## Codestack Academy SAN JOAQUIN COUNTY OF EDUCATION

#### **ADDENDUM #3**

FROM: ARCHITECHNICA

555 W. BENJAMIN HOLT DRIVE

SUITE 423

STOCKTON, CA 95207

(209) 952-5850 FAX (209) 952-2442

PROJECT: CODESTACK ACADEMY

LOCATION : 201 North California Street

Stockton CA 95202

REF. # : ARCH PROJ. No. 2023-04

OWNER : San Joaquin County of Education

2922 Transworld Drive Stockton, CA 95206

DATE: 27 November 2024

#### NOTICE TO ALL BIDDERS

IT IS THE PURPOSE AND INTENT OF THIS ADDENDUM TO MODIFY AND/OR CLARIFY THE DRAWINGS AND SPECIFICATIONS FOR THIS PROJECT AND THIS ADDENDUM SHALL BECOME A PART OF THE CONTRACT DOCUMENTS. THESE CHANGES AND/OR INTERPRETATIONS SHALL BE INCORPORATED INTO YOUR BID.

REFER TO PROJECT PLANS AND SPECIFICATIONS PREPARED BY ARCHITECHNICA, COVER SHEET DATED 4 November 2024

#### **GENERAL**

#### ITEM 1 LOW VOLTAGE WORK

Installations and cabling for low voltage work as noted below will be provided by owner or owner's contractors.

- Data Cabling
- Security/Intrusion Alarm
- Audio Visual

#### ITEM 2 PROJECT MANUAL

Removed SECTION 31 23 23 .43 – Geofoam (pages 906-908)

#### ITEM 3 PROJECT MANUAL –addition to project manual

ADD SECTION 06 16 00- SHEATHING

Clarification; Callouts for Glass mat sheathing on Architectural details shall be Securock ExoAir 430. All 5/8" GLASS MAT SHEATHING on exterior elevation shall be Securock ExoAir 430 as part of Dryvit Outsolation Plus MD Securock ExoAir 430 finish system. Also referred to in Architectural details as "Dryvit System".

#### ADDENDUM #3

#### CIVIL

#### ITEM 1 Sheets CS1, CS2:

- Revise Signage callout for Stop sign
- location of tow away sign moved to fence
- Add note #20 for FUTURE EV Charging stations. Stations at North of parking lot noted as FUTURE EV charging stations.

#### ITEM 2 Sheets UT1, UT2:

- Water Service Sizing Coordination with Plumbing and Landscape
- Add/ Identify drainage route for Building Perimeter drain (Sheet UT1)

#### ITEM 3 Sheet CD.1:

Valley Gutter Detail added to Sheet.

#### **ARCHITECTURAL**

#### ITEM 1 <u>A2.1 - BASEMENT</u>

Wall on Grid (3), Grid (C-K) moved 9" toward east; coffee area sink/counter and printer flipped. Structural columns at Grid 3, increased.

#### ITEM 2 A2.1 – DRAINAGE PIPE

Added callout for drainage pipe at perimeter of new foundation walls at basement

#### ITEM 3 A7.03 - COFFEE

Due to Structural columns at Grid 3, increasing, coffee area sink/counter and printer flipped.

#### ITEM 4 A9.2.11

Added detailing for beam to wall. Detail 16.

#### ITEM 5 <u>A9.2.8</u>

Added waterproofing detailing at existing basement to be filled in. DMAetail 3.

#### **MECHANICAL**

#### ITEM 1 SHEET M1.0

Revisions to vent location due to coffee reconfiguration.

#### ITEM 2 SHEET M1.1

Revisions to equipment locations in electrical switchgear room per plancheck comments.

#### **PLUMBING**

#### ITEM 1 SHEET P1.0

Revisions to vent location due to coffee reconfiguration.

#### ADDENDUM #3

#### **ELECTRICAL**

ITEM 1 SHEET E1.1

Reference to sheet 1/E1.3 and correct location of Main switchboard

ITEM 2 SHEET E1.3 – new sheet

PGE street connectivity diagram with dimensions.

ITEM 3 SHEET E2.1.2

Revisions to equipment locations in electrical switchgear room per plancheck comments.

Attachments: Section 06 16 00, Civil Sheets CS1, CS2, UT1, UT2, CD1, Electrical Sheets E1.1, A1.3, A2.1.2, Architectural sheets A2.1, A7.03, A9.2.11, A9.2.8

**END OF ADDENDUM #3** 

**ARCHITECHNICA** 

Ву

Tim Dearborn, AIA

Architect

RENEWAL

12/2025 CAL

#### **SECTION 06 16 00 - SHEATHING**

#### **PART 1 GENERAL**

#### 1.01 SECTION INCLUDES

A. Sheathing.

#### 1.02 RELATED REQUIREMENTS

A. 07 24 19 - EIFS

#### 1.03 REFERENCE STANDARDS

- A. ASTM C1177/C1177M Standard Specification for Glass Mat Gypsum Substrate for Use as Sheathing; 2017.
- B. ASTM E96/E96M Standard Test Methods for Gravimetric Determination of Water Vapor Transmission Rate of Materials; 2023.
- C. ASTM E2178 Standard Test Method for Determining Air Leakage Rate and Calculation of Air Permeance of Building Materials; 2021a.
- D. ASTM E2357 Standard Test Method for Determining Air Leakage Rate of Air Barrier Assemblies; 2024.

#### 1.04 SUBMITTALS

- A. See Section 01 30 00 Administrative Requirements for submittal procedures.
- B. Specimen warranty.

#### 1.05 QUALITY ASSURANCE

A. Use materials evaluated by Air Barrier Association of America (ABAA).

#### 1.06 DELIVERY, STORAGE, AND HANDLING

- A. See Section 01 74 19 Construction Waste Management and Disposal for packaging waste requirements.
- B. Store products above ground in dry ventilated space to protect against moisture. Support stacked products to prevent deformation and allow air circulation.
- C. Protect materials from soiling and damage.
- D. Deliver materials to site promptly without undue exposure to weather.
- E. Deliver in manufacturer's unopened containers, pallets, or panels fully identified with name, brand, type, and grade.

#### 1.07 WARRANTY

- A. See Section 01 78 00 Closeout Submittals for additional warranty requirements.
- B. Manufacturer Warranty: Provide warranty for material defects and fabrication as noted in manufacturer's documentation. Complete forms in Owner's name and register with manufacturer.

#### **PART 2 PRODUCTS**

#### 2.01 SHEATHING

- A. Glass-mat-faced gypsum wall sheathing with integral water-resistive and air barrier, comply with ASTM C1177/C1177M.
  - 1. Size: 48 by 96 inches, nominal.
  - 2. Thickness: 5/8 inch.

SHEATHING 06 16 00 - 1

- Edges: Square.
- Water Vapor Permeance: 1 perm, minimum, when tested in accordance with ASTM E96/E96M.
- 5. Air Permeance, Sheathing: 0.001 cfm/sq ft, maximum, when tested in accordance with ASTM E2178.
- Air Permeance, Assembly: 0.04 cfm/sq ft, maximum, when tested in accordance with ASTM E2357.
- 7. Products:
  - a. USG Corporation; Securock ExoAir 430 Panel.
  - b. Substitutions: See Section 01 60 00 Product Requirements.

#### 2.02 ACCESSORIES

- A. Fasteners and Anchors:
  - 1. General: Refer to manufacturer product information for fastener types and requirements.

#### **PART 3 EXECUTION**

#### 3.01 EXAMINATION


- A. Examine substrates and adjoining construction.
- B. Replace damaged framing before installation of cementitious panel subfloor. Proceed with installation only after unsatisfactory conditions corrected.

#### 3.02 INSTALLATION


- A. Select material sizes to minimize waste.
- B. Reuse and clearly separate scrap for use on-site as accessory components, including shims, bracing, and blocking.
- C. Wall Sheathing with Integrated Water-Resistive Barrier and Air Barrier: Secure to studs in accordance with manufacturer's installation instructions.
  - 1. Install with water-resistive and air barrier on exterior side of sheathing.
  - 2. Do not bridge building expansion joints; cut and space edges of panels to match spacing of structural support elements.
  - 3. Do not install directly over masonry surfaces; use furring strips or framing.
  - 4. Apply manufacturer's standard seam sealants and transition membranes.

#### **END OF SECTION**

SHEATHING 06 16 00 - 2

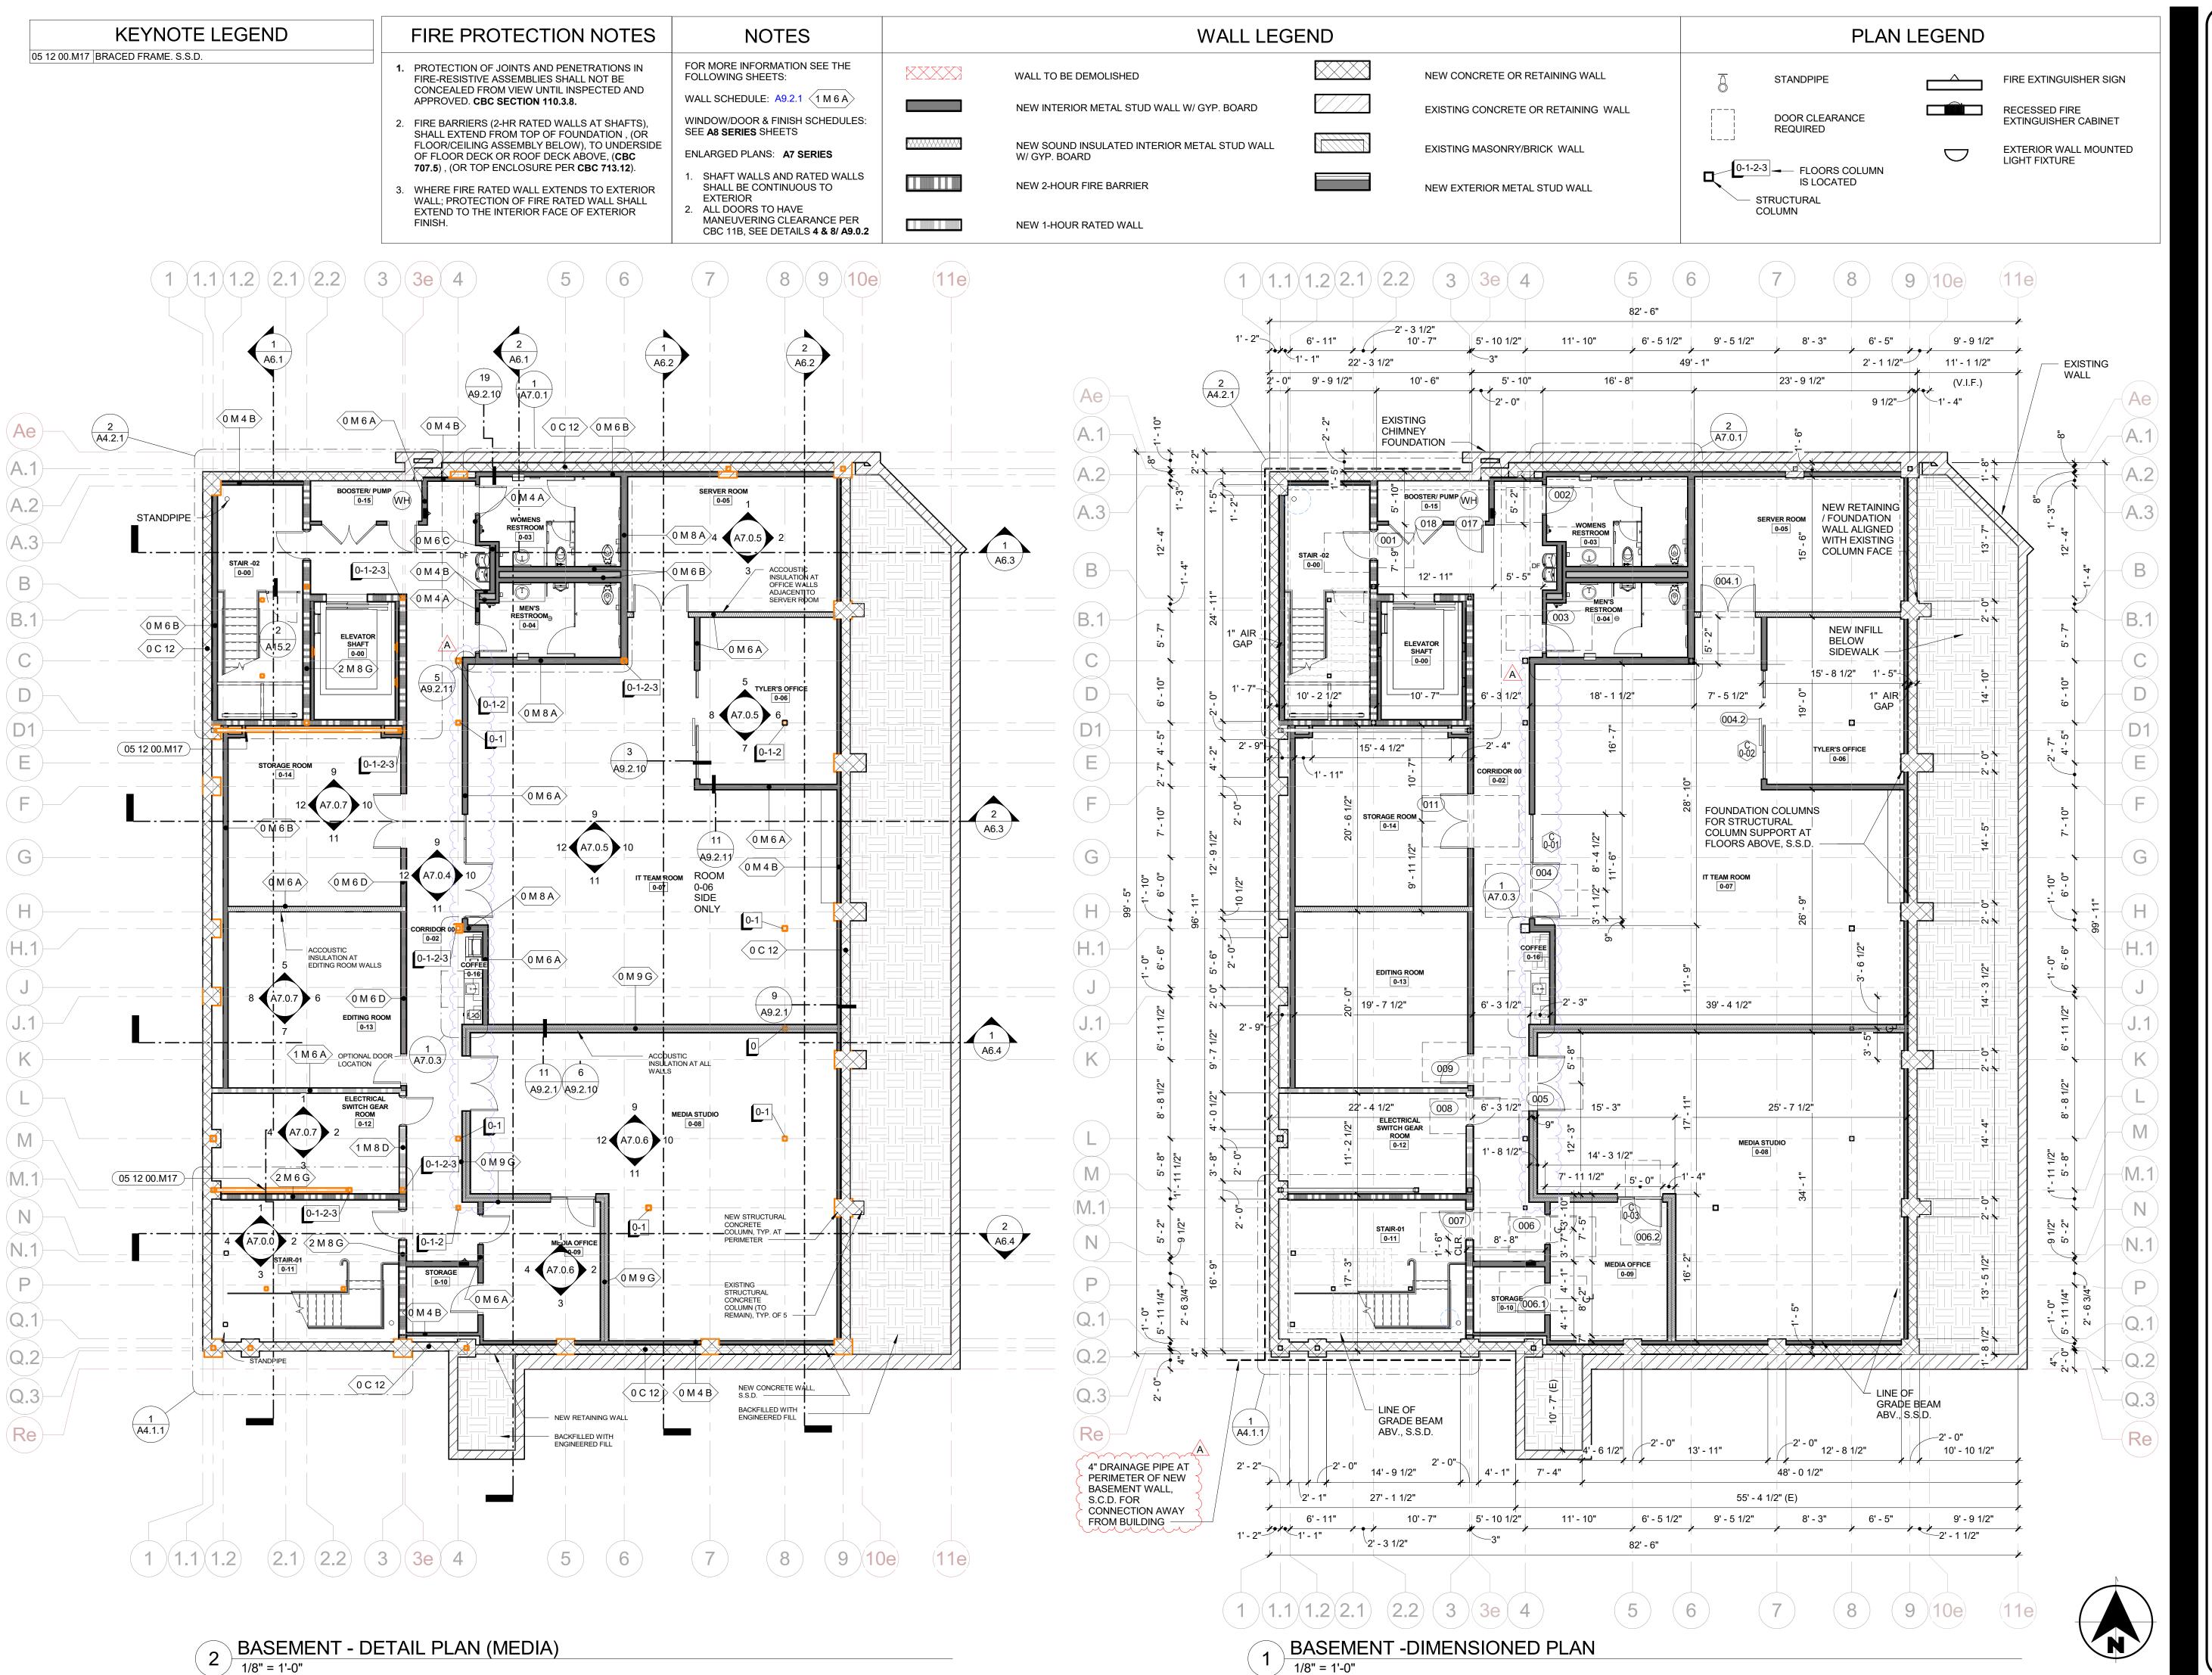

ACHITECHNICA 555 West Benjamin Holt Drive, Suite 423 Stockton, California 95207 **P**: (209) 952-5850 **F**: (209) 952-2442 E: hello@architechnica.net www.architechnica.net © 2024 ARCHITECHNICA CODESTACK **ACADEMY** 201 N CALIFORNIA ST STOCKTON, CA 95202 SAN JOAQUIN COUNTY OFFICE OF EDUCATION **REVISIONS** 1 INHOUSE REVISIONS STOCKTON FD PLNCHK A ADDENDA #1 11.05.24 PROJECT NO: 2023-04 ISSUE SET: BUILDING SUBMITTAL 2 ISSUE DATE: 11.26.24 DRAWN BY: LCG **BASEMENT-DIMENSION** & DETAIL PLAN A2.1

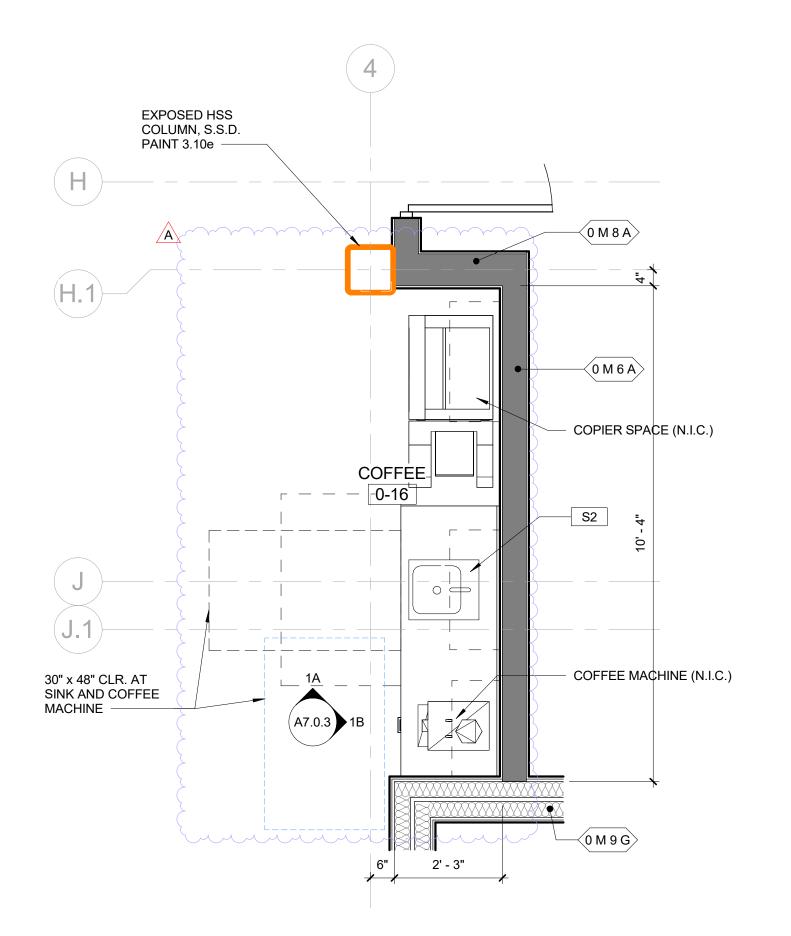

## 1 COFFEE AT BASEMENT - ENLARGED PLAN 1/2" = 1'-0"

MICROWAVE

- ISLAND COUNTER OPEN BELOW A7.0.3 2B

K2 A7.0.3

6' - 2"

(N.I.C.)

KITCHENETTE

3-16

16' - 8 7/8"

(A7.0.3)


10' - 0"

2 KITCHENETTE THIRD FLOOR - ENLARGED PLAN
1/2" = 1'-0"


REFG. (N.I.C.)


1' - 7 1/2"

/ \

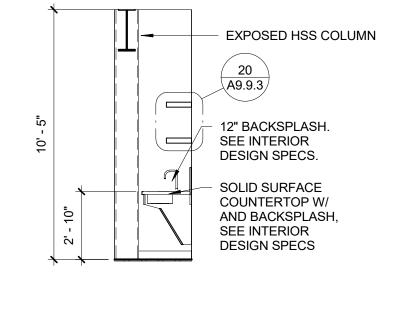

## 1A COFFEE AT BASEMENT - NORTH

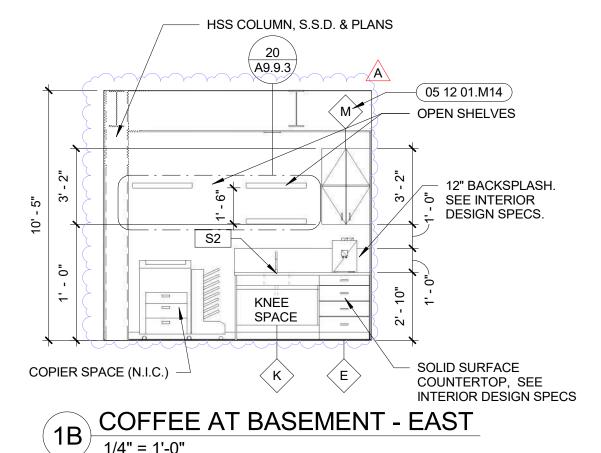

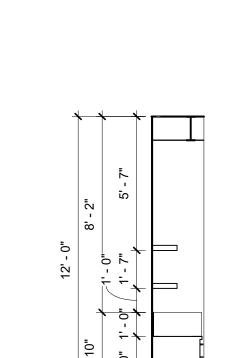


OPEN SHELVES

SOLID SURFACE COUNTER

BACK SPLASH



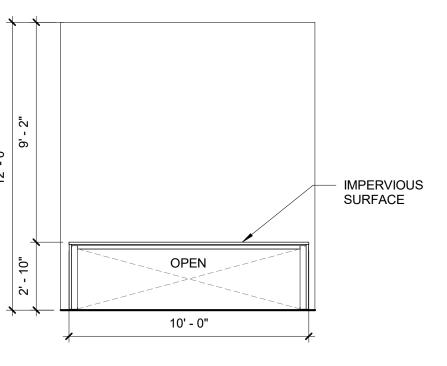

KITCHENETTE 03 - NORTH


K1 KITCHENETTE ISLAND 03 - A

- S3

MACHINE (N.I.C.)


30" X 48" CLEAR

SPACE

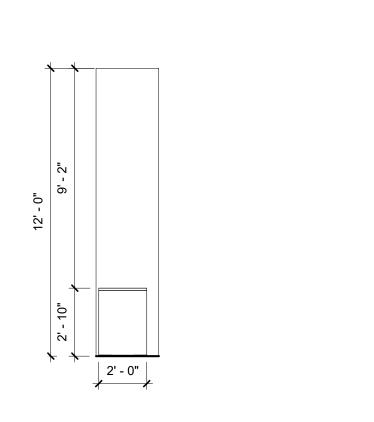

2' - 0"	
K2 KITCHENETTE ISLAND 03 - B 1/4" = 1'-0"	

#### PARTIAL TOILET / ACCESSORIES SCHEDULE MANUF. MARK ITEM NOTES MOUNTING MANUF. **DETAIL** NUMBER HEIGHT VRECESSED ACCESSIBLE HI-LO DRINKING FOUNTAIN CHILLER W/ $\left(17\right)\left(17\right)$ SEE DETAILS LZSTL8WSSP-DRINKING FOUNTAIN **ELKAY** A9.9.2 A9.0.2 TOUCHLESS BOTTLE FILLER TOP OF RIM AT 34" MAX. A.F.F. AND 27" WALL HUNG SERVICE SINK SERVICE SINK JUST A18665-J S2 A9.0.2 MIN. KNEE CLEARANCE UNDERMOUNT SINGLE BOWL TOP OF RIM AT 34" KITCHEN SINK KOHLER K-5409 MAX. A.F.F. AND 27" KITCHEN SINK S3 A9.0.2 MIN. KNEE CLEARANCE

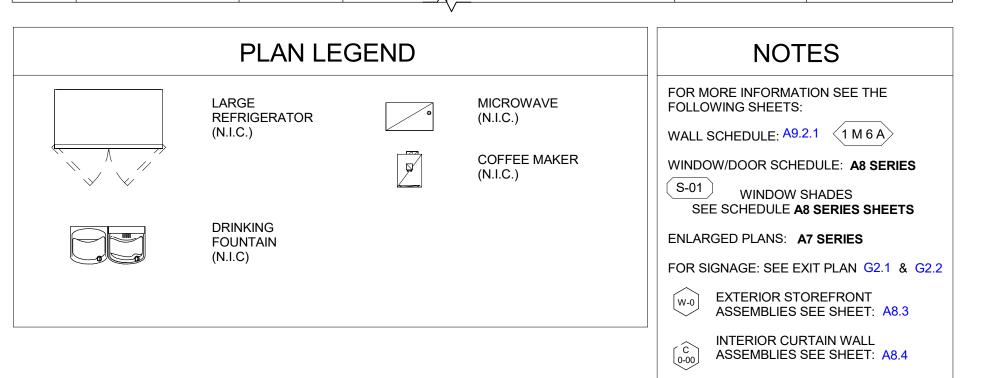


CASEWORK SCHEDULE-0-16-COFFEE & 3-16-KITCHENETTE							
SYMBOL	Model	Description	Width	Height	Depth	DETAIL	COMMENTS
Α	254	Base Cabinet w/ Drawers	1' - 6"	2' - 8 1/2"	2' - 0"	3 / A9.9.3	
С	302	Wall Hung Cabinet	3' - 3"	3' - 2"	1' - 0 1/2"	3 / A9.9.3	
D	101	Base Cabinet w/o Drawers	2' - 2"	2' - 8 1/2"	2' - 0"	3 / A9.9.3	
E	254	Base Cabinet w/ Drawers	2' - 1"	2' - 8 1/2"	2' - 0"	3 / A9.9.3	
G	102	Base Cabinet w/o Drawers	3' - 3"	2' - 8 1/2"	2' - 0"	3 / A9.9.3	
K	154 C	Base Cabinet w/o Drawers	3' - 6"	2' - 10"	2' - 0"	19 / A9.9.3	W/ SINK
М	302	Wall Hung Cabinet	2' - 0"	3' - 2"	1' - 0"	3 / A9.9.3	

## CASEWORK

- 1. PLASTIC-LAMINE-FACED ARCHITECTURAL CABINETS AND COUNTERTOPS SHALL COMPLY WITH THE NORTH AMERICAN ARCHITECTURAL WOODWORK STANDARDS (NAAWS 4.0) FOR CUSTOM CONSTRUCTION, FINISHES, INSTALLATION, AND OTHER REQUIREMENTS.
- 2. PROVIDE LABELS AND CERTIFICATES FROM WOODWORK INSTITUTE (WI) CERTIFICATION PROGRAM INDICATING THAT WOODWORK, INCLUDING INSTALLATION, COMPLIES WITH REQUIREMENTS OF GRADES SPECIFIED.
- NUMBER SIGNATIONS (CDS XXX) REFER TO WI CASEWORK DESIGN SERIES (CDS) NUMBERS IN NAAWS 4.0.
   HARDWOOD PLYWOOD, PARTICLEBOARD, AND MEDIUM DENSITY FIBERBOARD COMPOSITE
- WOOD PRODUCTS SHALL MEET THE REQUIREMENTS FOR FORMALDEHYDE AS SPECIFIED IN CALIFORNIA AIR RESOURCES BOARD'S (ARB) AIR TOXICS CONTROL MEASURE (ATCM) FOR COMPOSITE WOOD (CCR TITLE 17, SECTION 93120, ET SEQ.) MATERIALS NOT EXEMPTED UNDER ATCM MUST MEET THE SPECIFIED EMISSION LIMITS AS SHOWN IN GBC TABLE 5.504.4.5.


  5. SEE INTERIOR DESIGN SPECIFICATIONS FOR COUNTERTOP AND BACKSPLASH SURFACES.

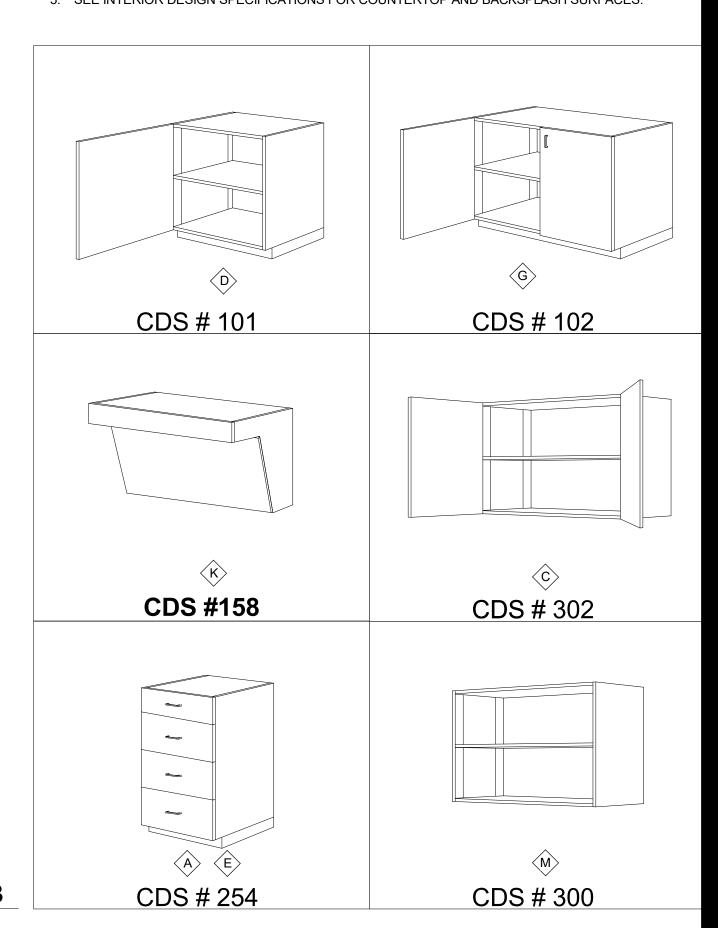





CONSULTANT

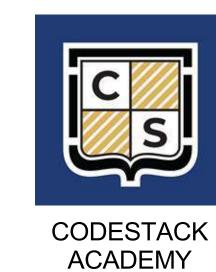

201 N CALIFORNIA ST, STOCKTON, CA 95202

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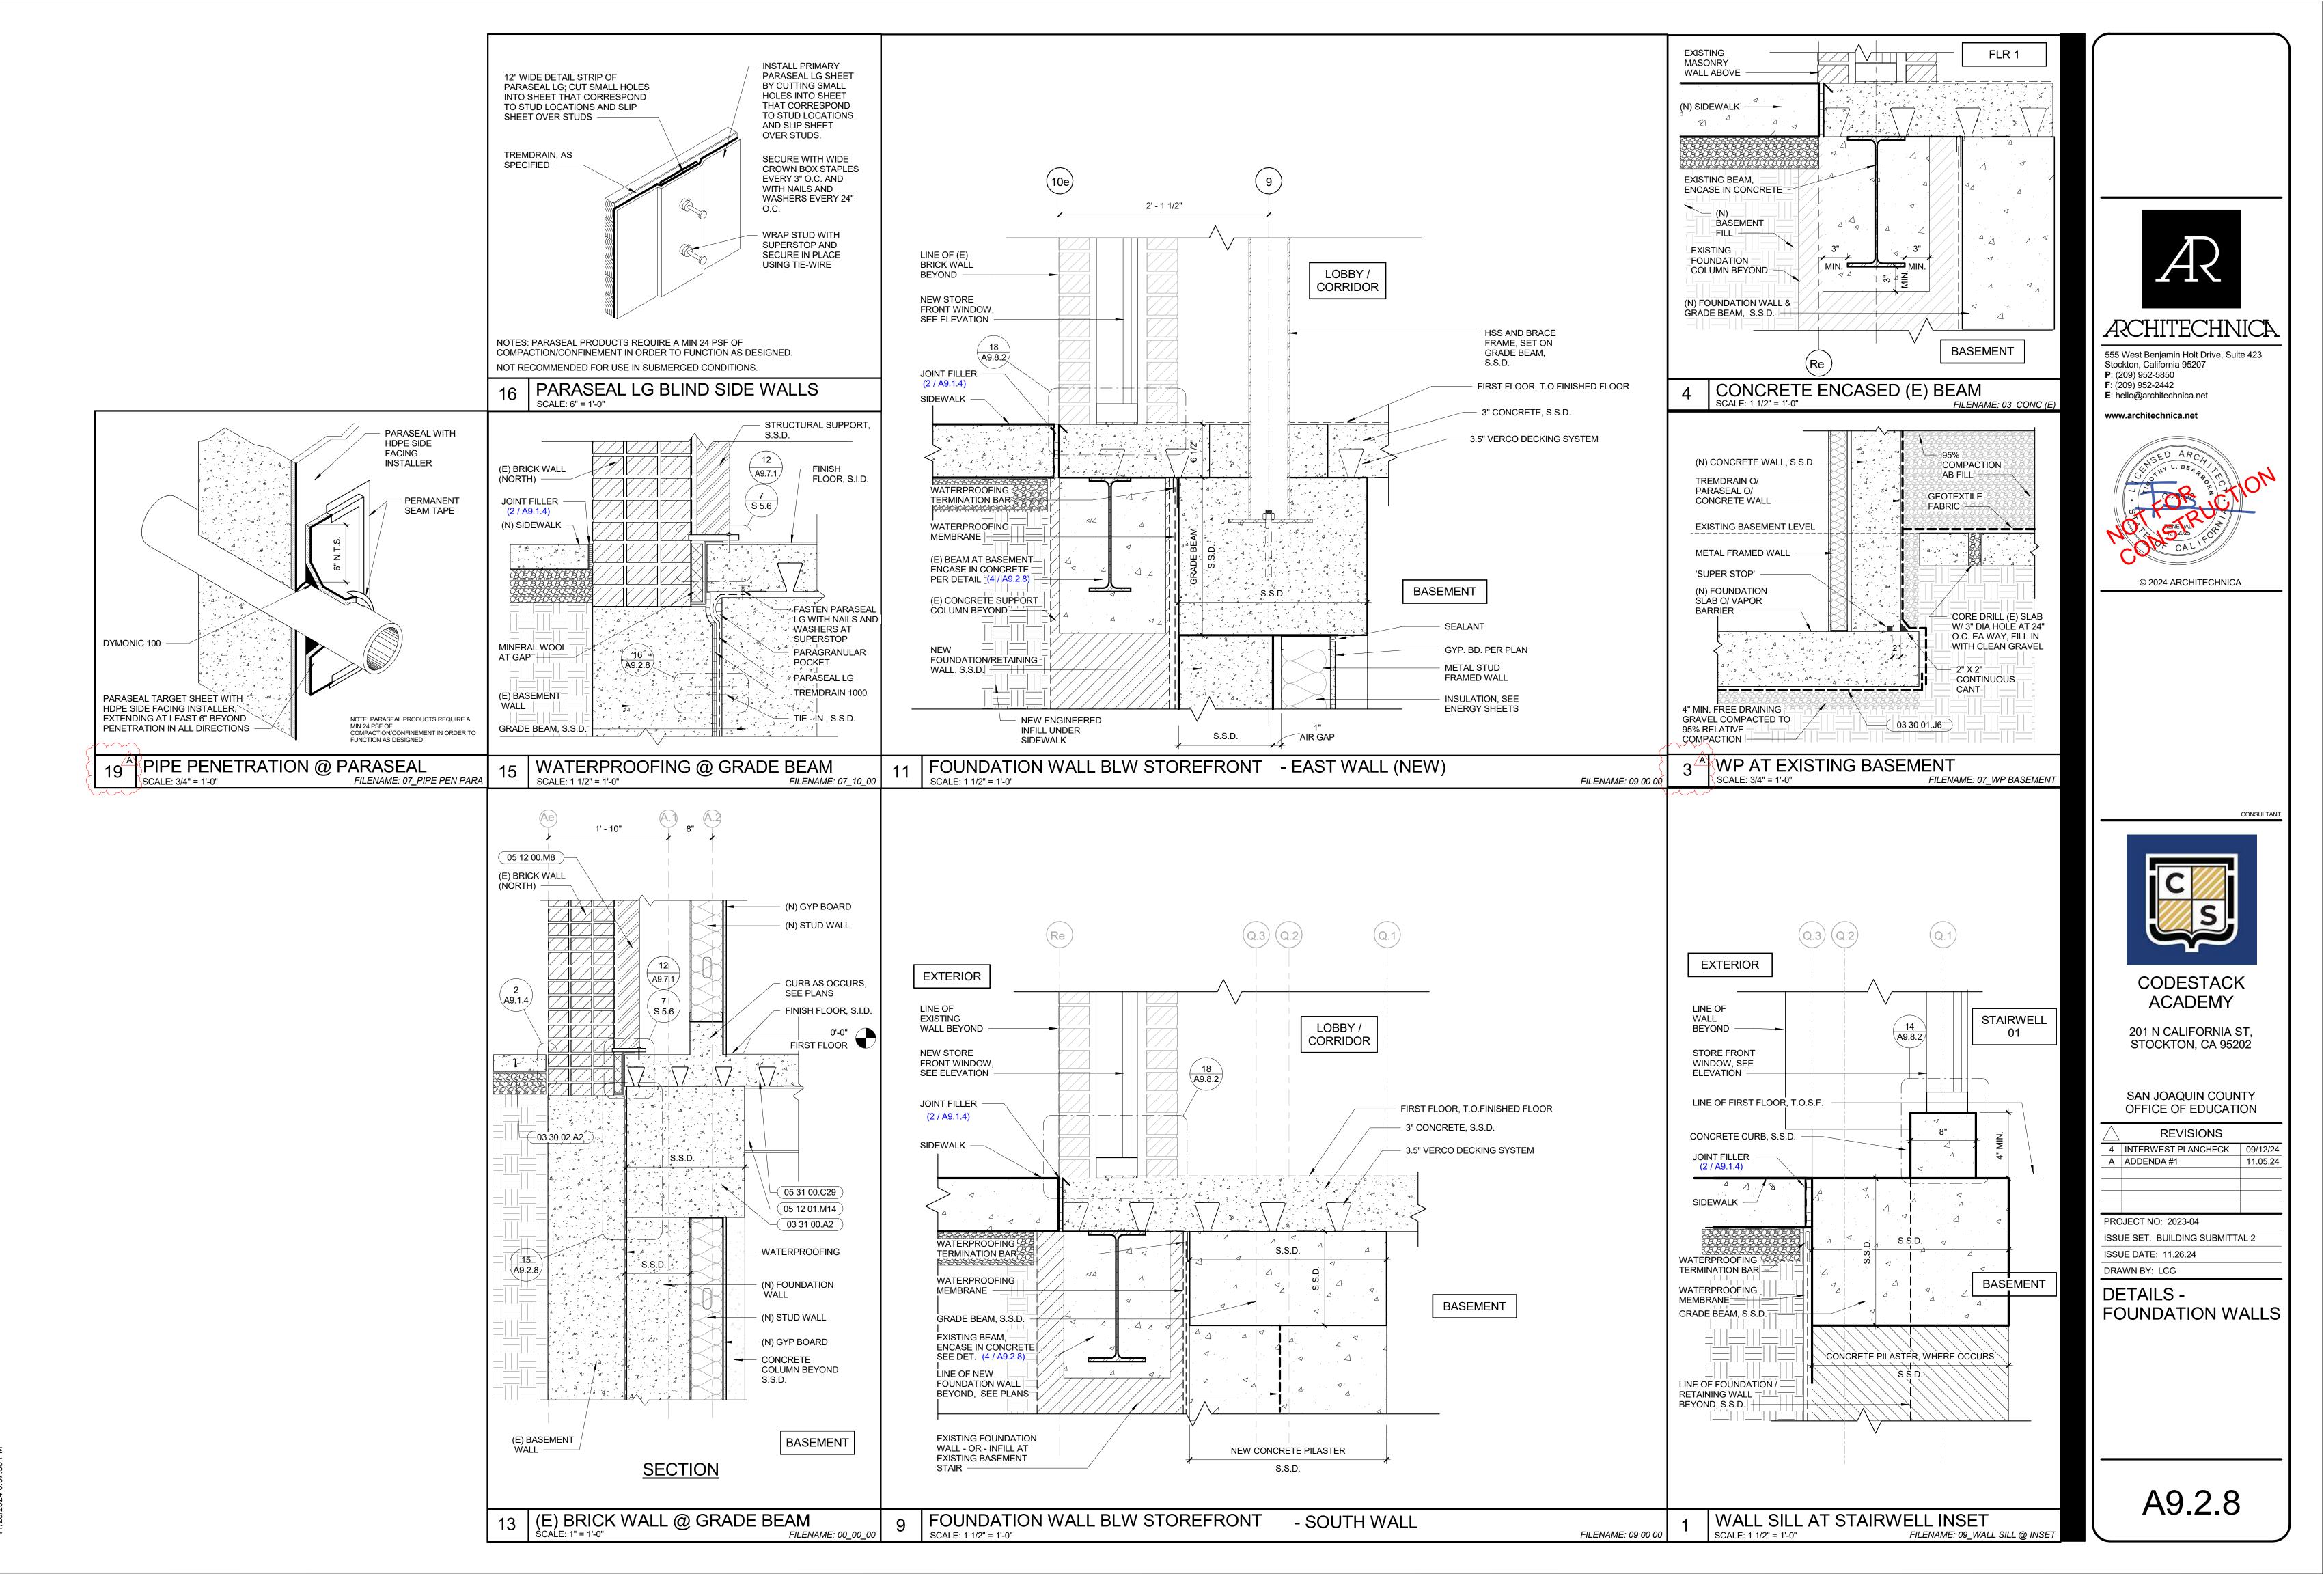
REVISIONS				
4 INTERWEST PLANCHECK	09/12/2			
A ADDENDA #1	11.05.2			
PROJECT NO: 2023-04				
ISSUE SET: BUILDING SUBMITTA	AL 2			
ISSUE DATE: 11.26.24				
DRAWN BY: JY				
COFFEE AT BASEMENT & KITCHENETTE AT THIRD FLOOR - ENLARGED PLANS, INTERIOR ELEVS, MILLWORK TYPES,				


A7.0.3

AND MILLWORK

SCHEDULE

D D1



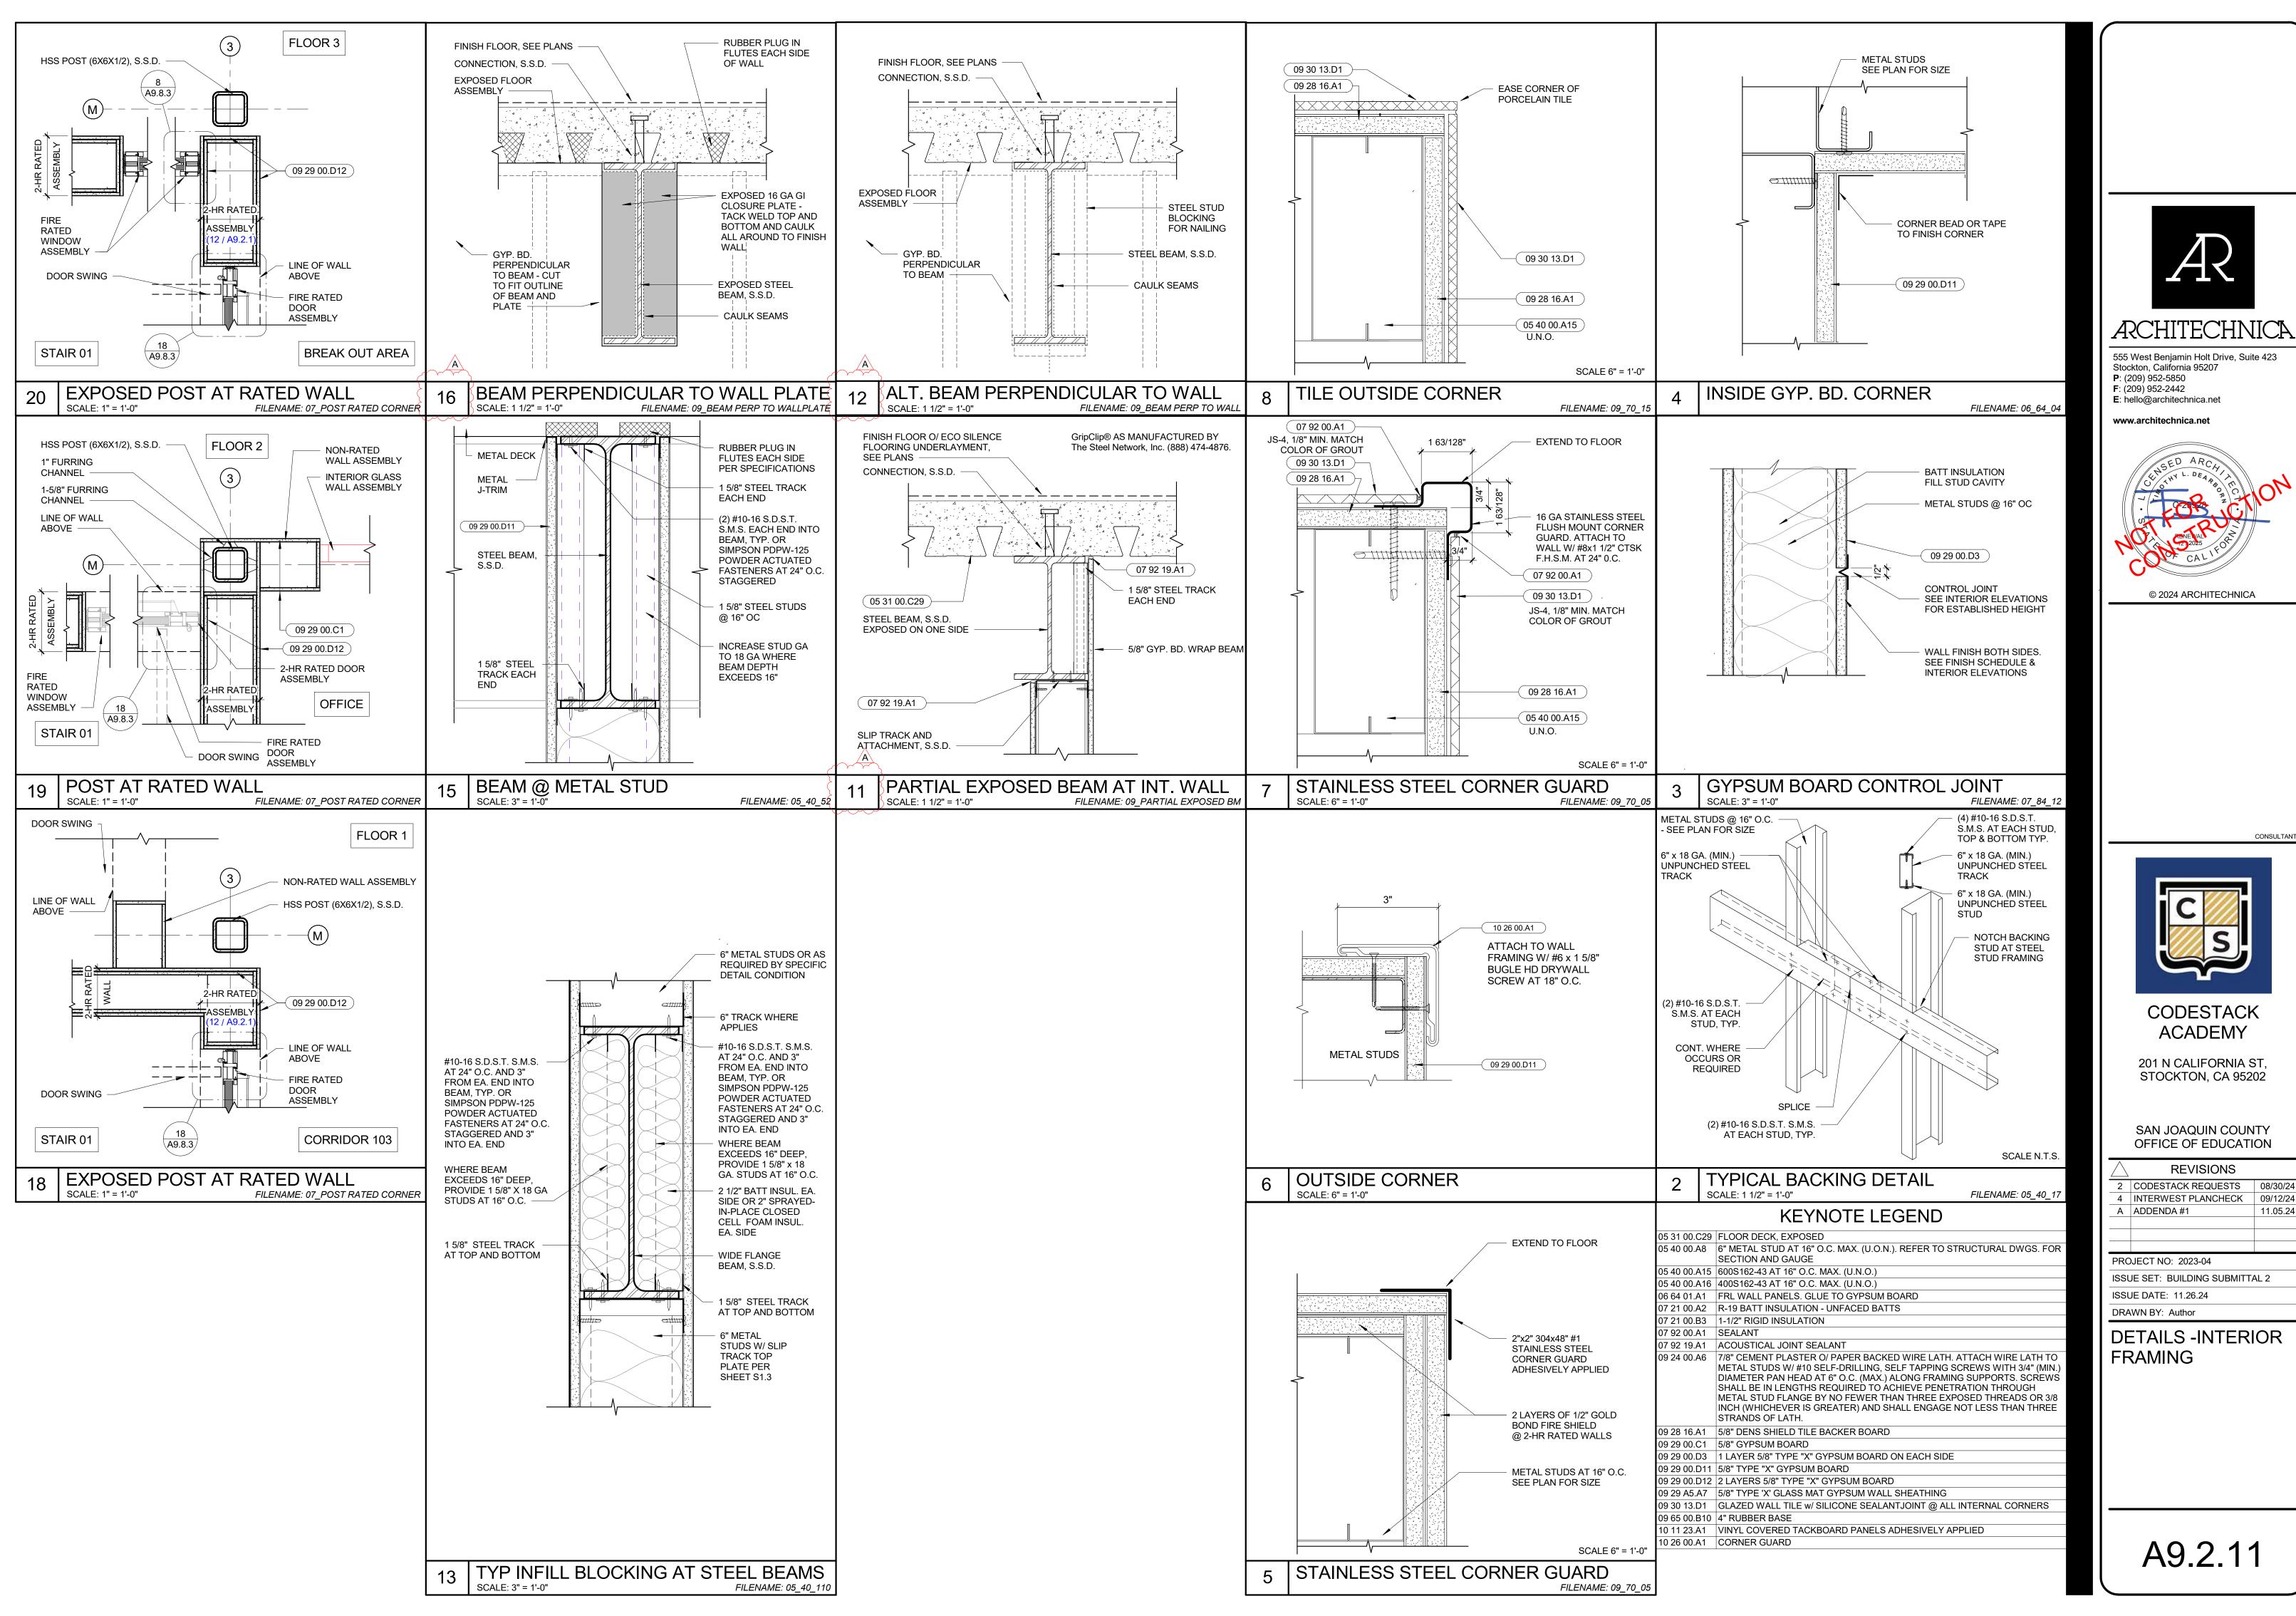

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> CODESTACK **ACADEMY**

> > 201 N CALIFORNIA ST STOCKTON, CA 95202

SAN JOAQUIN COUNTY OFFICE OF EDUCATION

REVISIONS

INTERWEST PLANCHECK 09/12/24


ADDENDA #1 11.05.24 PROJECT NO: 2023-04


ISSUE SET: BUILDING SUBMITTAL 2 ISSUE DATE: 11.26.24

DRAWN BY: Author

**DETAILS -INTERIOR** FRAMING

A9.2.11

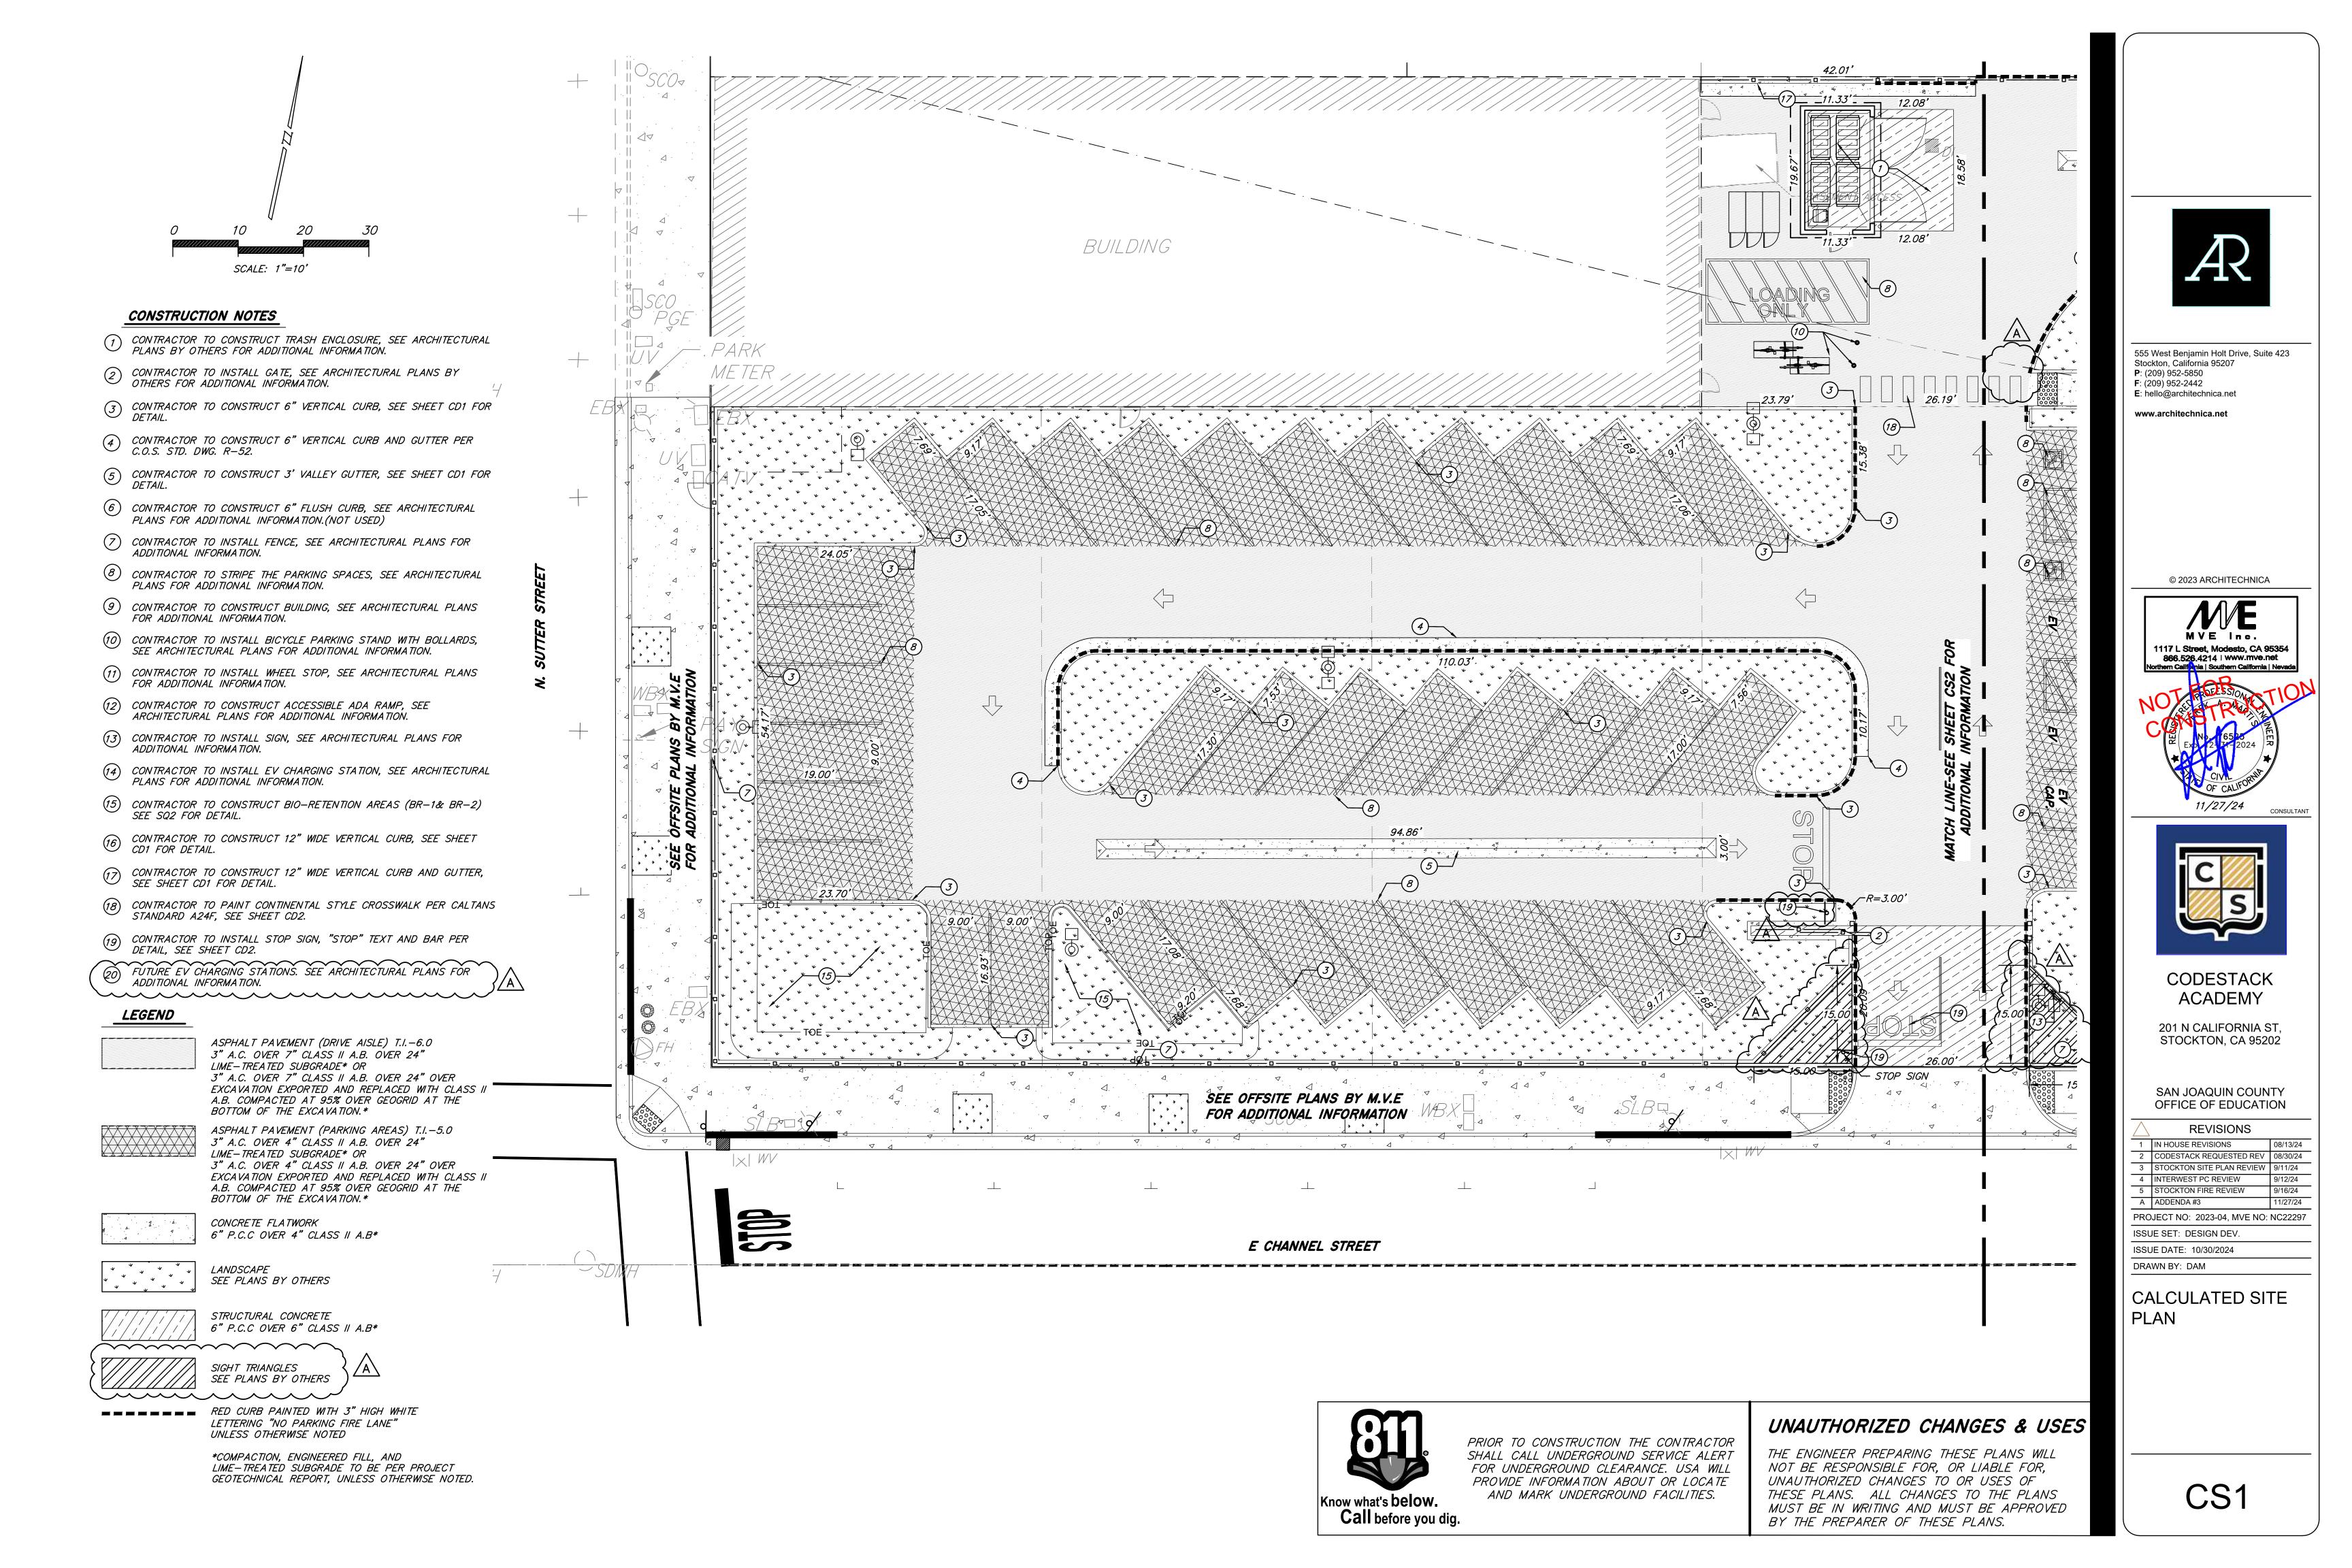

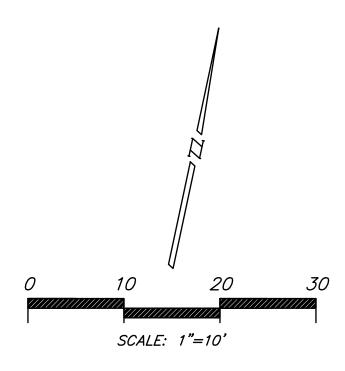

### CONSTRUCTION NOTES

- (1) CONTRACTOR TO CONSTRUCT TRASH ENCLOSURE, SEE ARCHITECTURAL PLANS BY OTHERS FOR ADDITIONAL INFORMATION.
- 2 CONTRACTOR TO INSTALL GATE, SEE ARCHITECTURAL PLANS BY OTHERS FOR ADDITIONAL INFORMATION.
- (3) CONTRACTOR TO CONSTRUCT 6" VERTICAL CURB, SEE SHEET CD1 FOR DETAIL.
- GONTRACTOR TO CONSTRUCT 6" VERTICAL CURB AND GUTTER PER C.O.S. STD. DWG. R-52.
- (5) CONTRACTOR TO CONSTRUCT 3' VALLEY GUTTER, SEE SHEET CD1 FOR DETAIL.
- 6 CONTRACTOR TO CONSTRUCT 6" FLUSH CURB, SEE ARCHITECTURAL PLANS FOR ADDITIONAL INFORMATION.(NOT USED)
- 7 CONTRACTOR TO INSTALL FENCE, SEE ARCHITECTURAL PLANS FOR ADDITIONAL INFORMATION.
- 8 CONTRACTOR TO STRIPE THE PARKING SPACES, SEE ARCHITECTURAL PLANS FOR ADDITIONAL INFORMATION.
- 9 CONTRACTOR TO CONSTRUCT BUILDING, SEE ARCHITECTURAL PLANS FOR ADDITIONAL INFORMATION.
- (10) CONTRACTOR TO INSTALL BICYCLE PARKING STAND WITH BOLLARDS, SEE ARCHITECTURAL PLANS FOR ADDITIONAL INFORMATION.
- (11) CONTRACTOR TO INSTALL WHEEL STOP, SEE ARCHITECTURAL PLANS FOR ADDITIONAL INFORMATION.
- (12) CONTRACTOR TO CONSTRUCT ACCESSIBLE ADA RAMP, SEE ARCHITECTURAL PLANS FOR ADDITIONAL INFORMATION.
- (3) CONTRACTOR TO INSTALL SIGN, SEE ARCHITECTURAL PLANS FOR ADDITIONAL INFORMATION.
- (14) CONTRACTOR TO INSTALL EV CHARGING STATION, SEE ARCHITECTURAL PLANS FOR ADDITIONAL INFORMATION.
- (5) CONTRACTOR TO CONSTRUCT BIO-RETENTION AREAS (BR-1& BR-2)
- (6) CONTRACTOR TO CONSTRUCT 12" WIDE VERTICAL CURB, SEE SHEET
- (17) CONTRACTOR TO CONSTRUCT 12" WIDE VERTICAL CURB AND GUTTER, SEE SHEET CD1 FOR DETAIL.
- (18) CONTRACTOR TO PAINT CONTINENTAL STYLE CROSSWALK PER CALTANS STANDARD A24F, SEE SHEET CD2.
- (9) CONTRACTOR TO INSTALL STOP SIGN, "STOP" TEXT AND BAR PER DETAIL, SEE SHEET CD2.
- FUTURE EV CHARGING STATIONS. SEE ARCHITECTURAL PLANS FOR ADDITIONAL INFORMATION.

## LEGEND

\_\_\_\_

ASPHALT PAVEMENT (DRIVE AISLE) T.I.-6.0 3" A.C. OVER 7" CLASS II A.B. OVER 24" LIME-TREATED SUBGRADE\* OR 3" A.C. OVER 7" CLASS II A.B. OVER 24" OVER EXCAVATION EXPORTED AND REPLACED WITH CLASS II A.B. COMPACTED AT 95% OVER GEOGRID AT THE BOTTOM OF THE EXCAVATION.\*

 $\mathsf{K} \times \mathsf{X} \times \mathsf{X} \times \mathsf{X} \times \mathsf{X} \times \mathsf{X}$ 

ASPHALT PAVEMENT (PARKING AREAS) T.I.-5.0 3" A.C. OVER 4" CLASS II A.B. OVER 24" LIME-TREATED SUBGRADE\* OR 3" A.C. OVER 4" CLASS II A.B. OVER 24" OVER EXCAVATION EXPORTED AND REPLACED WITH CLASS II A.B. COMPACTED AT 95% OVER GEOGRID AT THE BOTTOM OF THE EXCAVATION.\*

CONCRETE FLATWORK 6" P.C.C OVER 4" CLASS II A.B\*


*LANDSCAPE* SEE PLANS BY OTHERS

STRUCTURAL CONCRETE 6" P.C.C OVER 6" CLASS // A.B\*


SIGHT TRIANGLES SEE PLANS BY OTHERS

RED CURB PAINTED WITH 3" HIGH WHITE LETTERING "NO PARKING FIRE LANE" UNLESS OTHERWISE NOTED

> \*COMPACTION, ENGINEERED FILL, AND LIME-TREATED SUBGRADE TO BE PER PROJECT GEOTECHNICAL REPORT, UNLESS OTHERWISE NOTED.

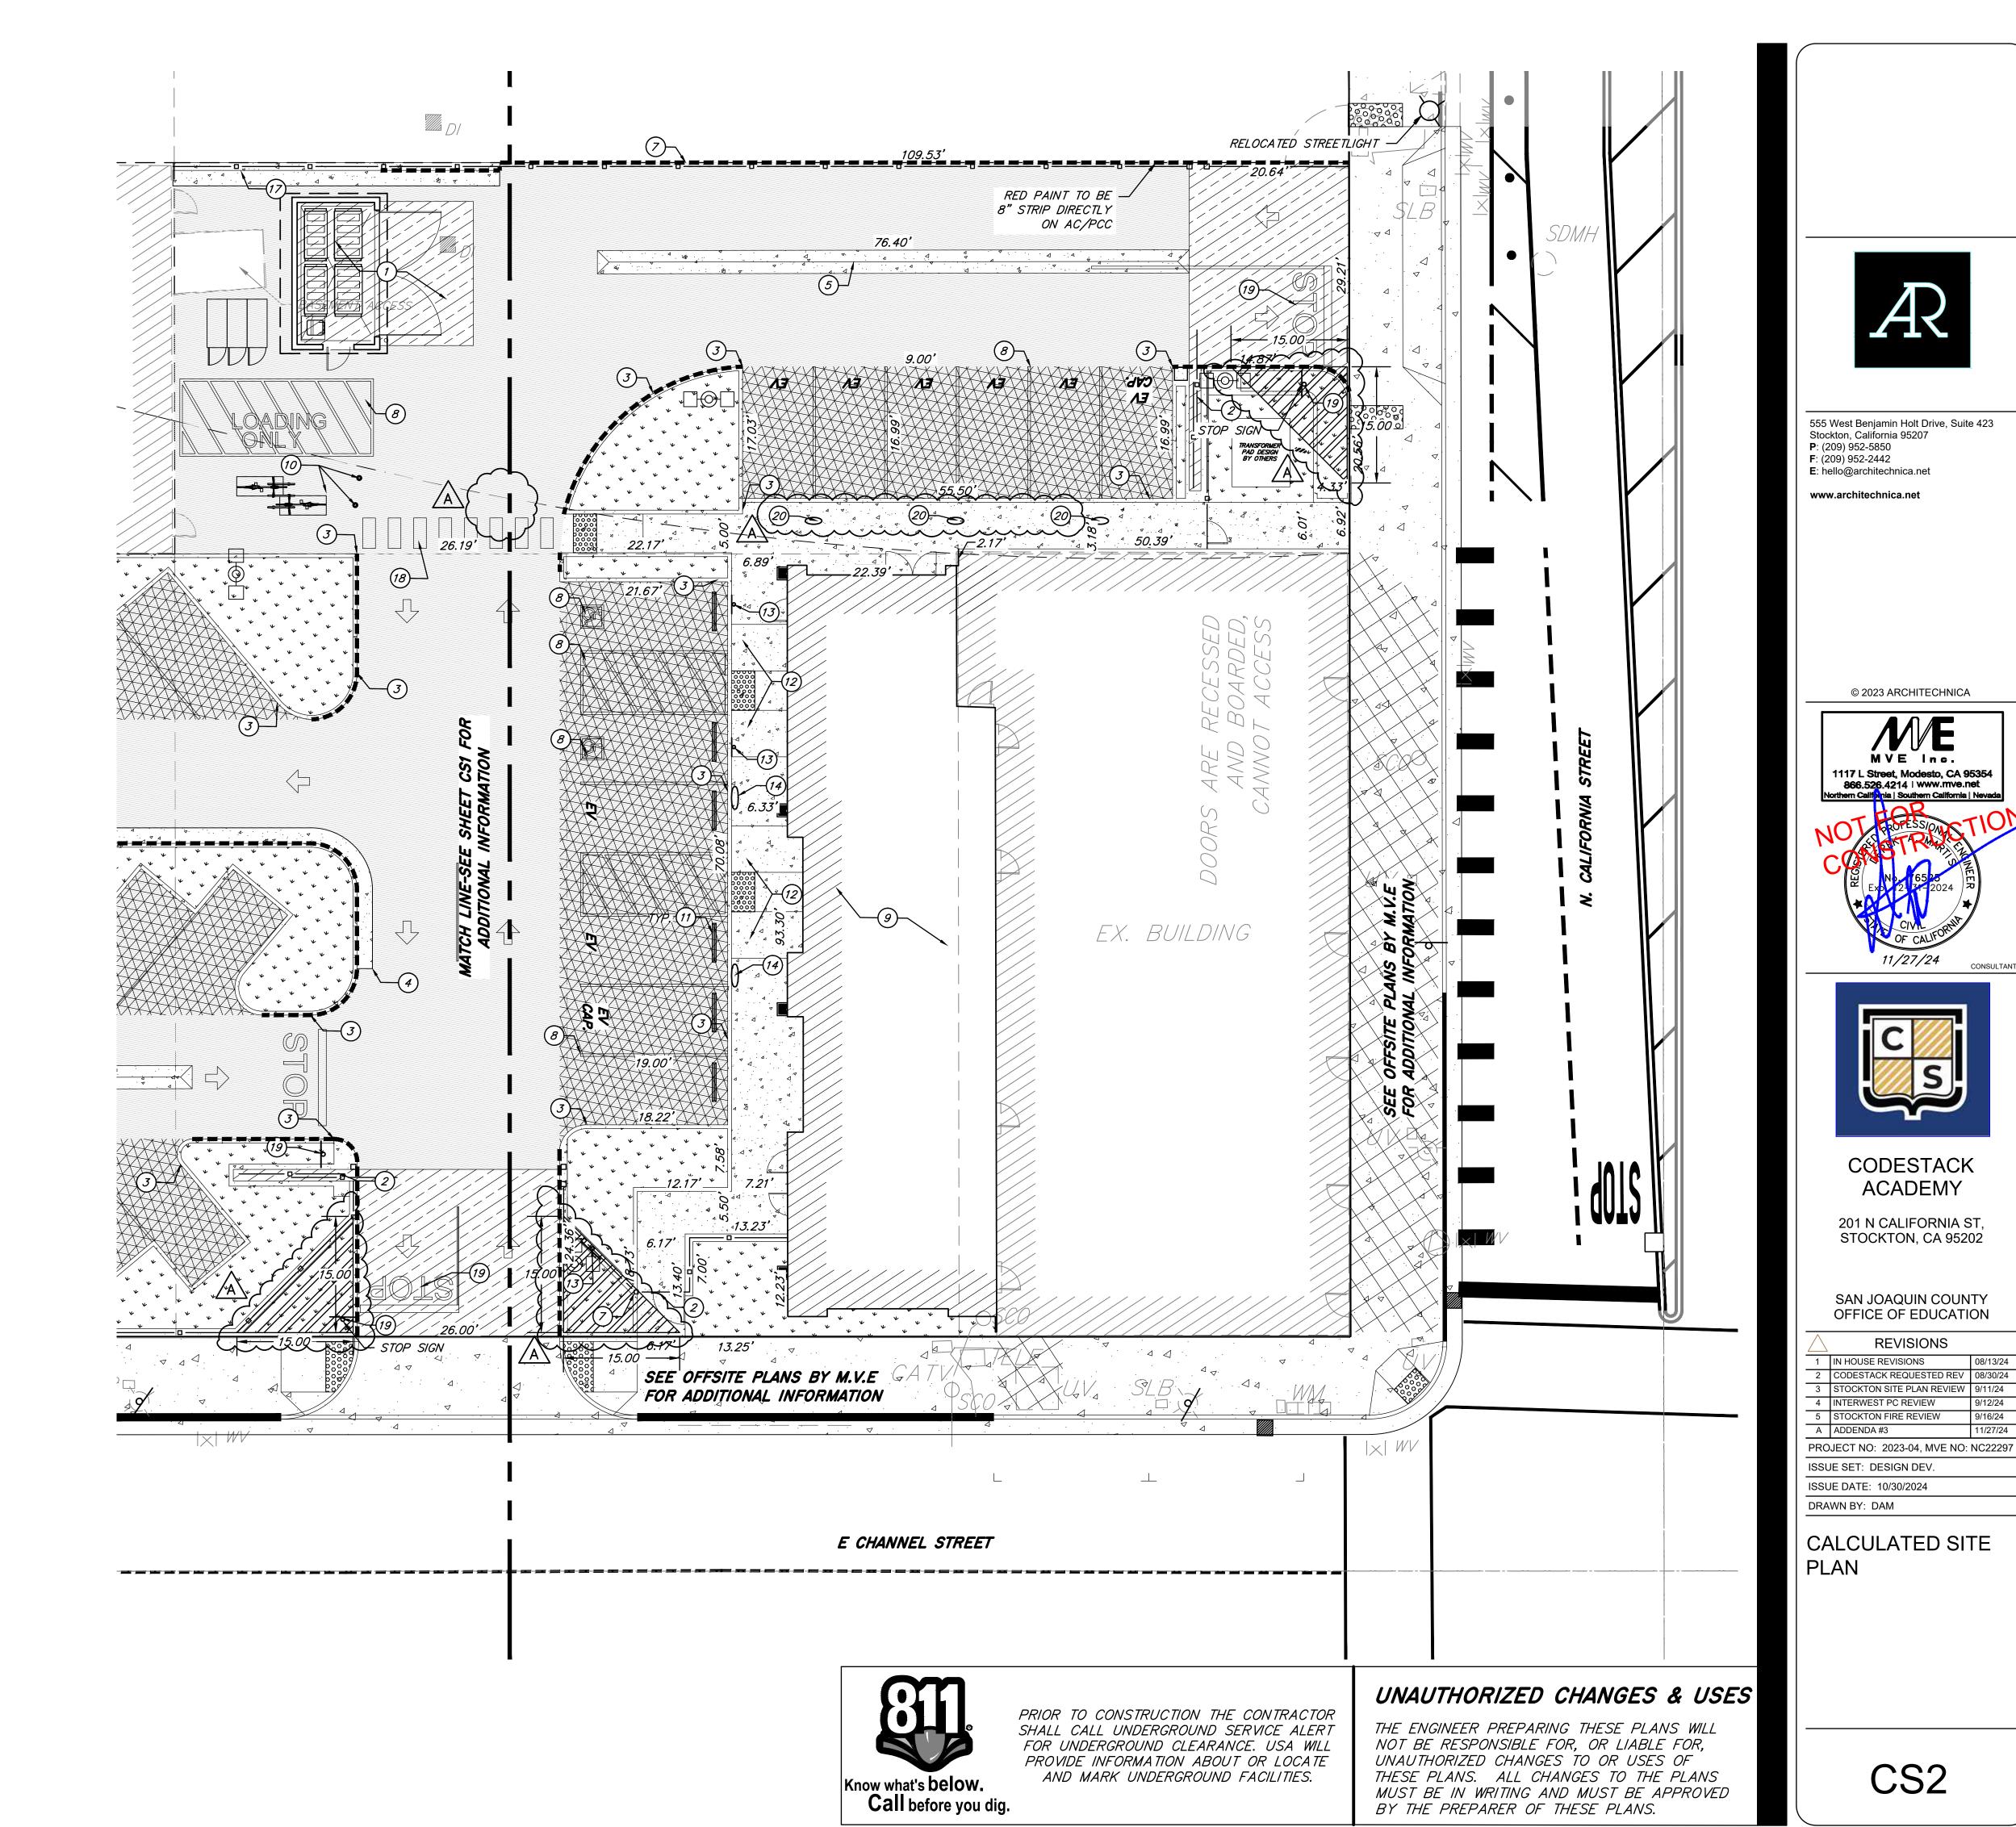

9/16/24

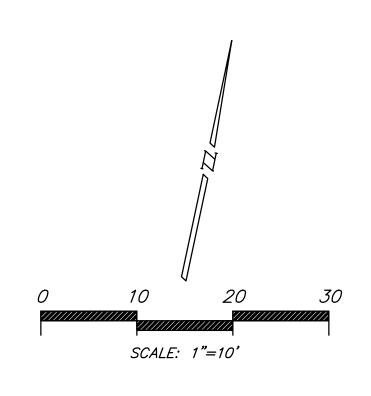

### LEGEND

- (\int INSTALL FIRE HYDRANT PER C.O.S. STD. DWG. W-13.
- INSTALL REDUCED PRESSURE BACKFLOW PREVENTION ASSEMBLY PER CALIFORNIA WATER STANDARDS.
- ₩ INSTALL WATER METER PER CALIFORNIA WATER STANDARDS.
- INSTALL SINGLE CHECK AND FIRE DEPARTMENT CONNECTION.
  PER C.O.S. STD. DWG. W-17.
- INSTALL REDUCED PRESSURE PRINCIPLE DETECTOR ASSEMBLY PER CALIFORNIA WATER STANDARDS.
- INSTALL AREA DRAIN. SEE SHEET CD1 FOR DETAIL.
- INSTALL OVERFLOW STRUCTURE, SEE SHEET CD1 FOR DETAIL.
- O INSTALL STORM DRAIN CLEANOUT, SEE SHEET CD1 FOR DETAIL.
- INSTALL SEWER AREA DRAIN, SEE SHEET CD1 FOR DETAIL.
- INSTALL SEWER CLEANOUT, SEE SHEET CD1 FOR DETAIL.
- = == 4" PERFORATED PIPE

### SANITARY SEWER NOTES


- SEWER POINT OF CONNECTION (P.O.C) TO BE 5' FROM BUILDING. FOR CONTINUATION, SEE PLUMBING PLANS BY OTHERS FOR ADDITIONAL INFORMATION. CONNECT TO THE BUILDING WITH 4" P.V.C. USE ELBOWS AS NECESSARY TO MEET BUILDING SEWER INVERTS. VERIFY FINAL LOCATION WITH PLUMBING PLANS BY OTHERS
- (2) CONTRACTOR TO POT HOLE AND VERIFY THE INVERT PRIOR TO CONSTRUCTION.
- 3 CONTRACTOR TO OBTAIN A ENCROACHMENT PERMIT FROM CITY PRIOR TO CONSTRUCTION.

### STORM DRAIN NOTES

- 4 CONTRACTOR TO INSTALL 4" PERFORATED PIPE, SEE SHEET CD1 FOR DETAIL.
- 4" PIPE BY OTHERS. SEE ARCHITECTURAL PLANS FOR ADDITIONAL INFORMATION.
- CONTRACTOR TO ADJUST STRUCTURE TO GRADE. INSTALL TRAFFIC RATED SOLID COVER.

### WATER NOTES

- WATER SERVICE POINT OF CONNECTION (P.O.C) TO BE 5' FROM BUILDINGS. FOR CONTINUATION, SEE PLUMBING PLANS BY OTHERS FOR ADDITIONAL INFORMATION.
- FIRE WATER SPRINKLER SERVICE POINT OF CONNECTION (P.O.C) TO BE 5' FROM BUILDING. FOR CONTINUATION, SEE FIRE SPRINKLER PLANS BY OTHERS FOR ADDITIONAL INFORMATION.

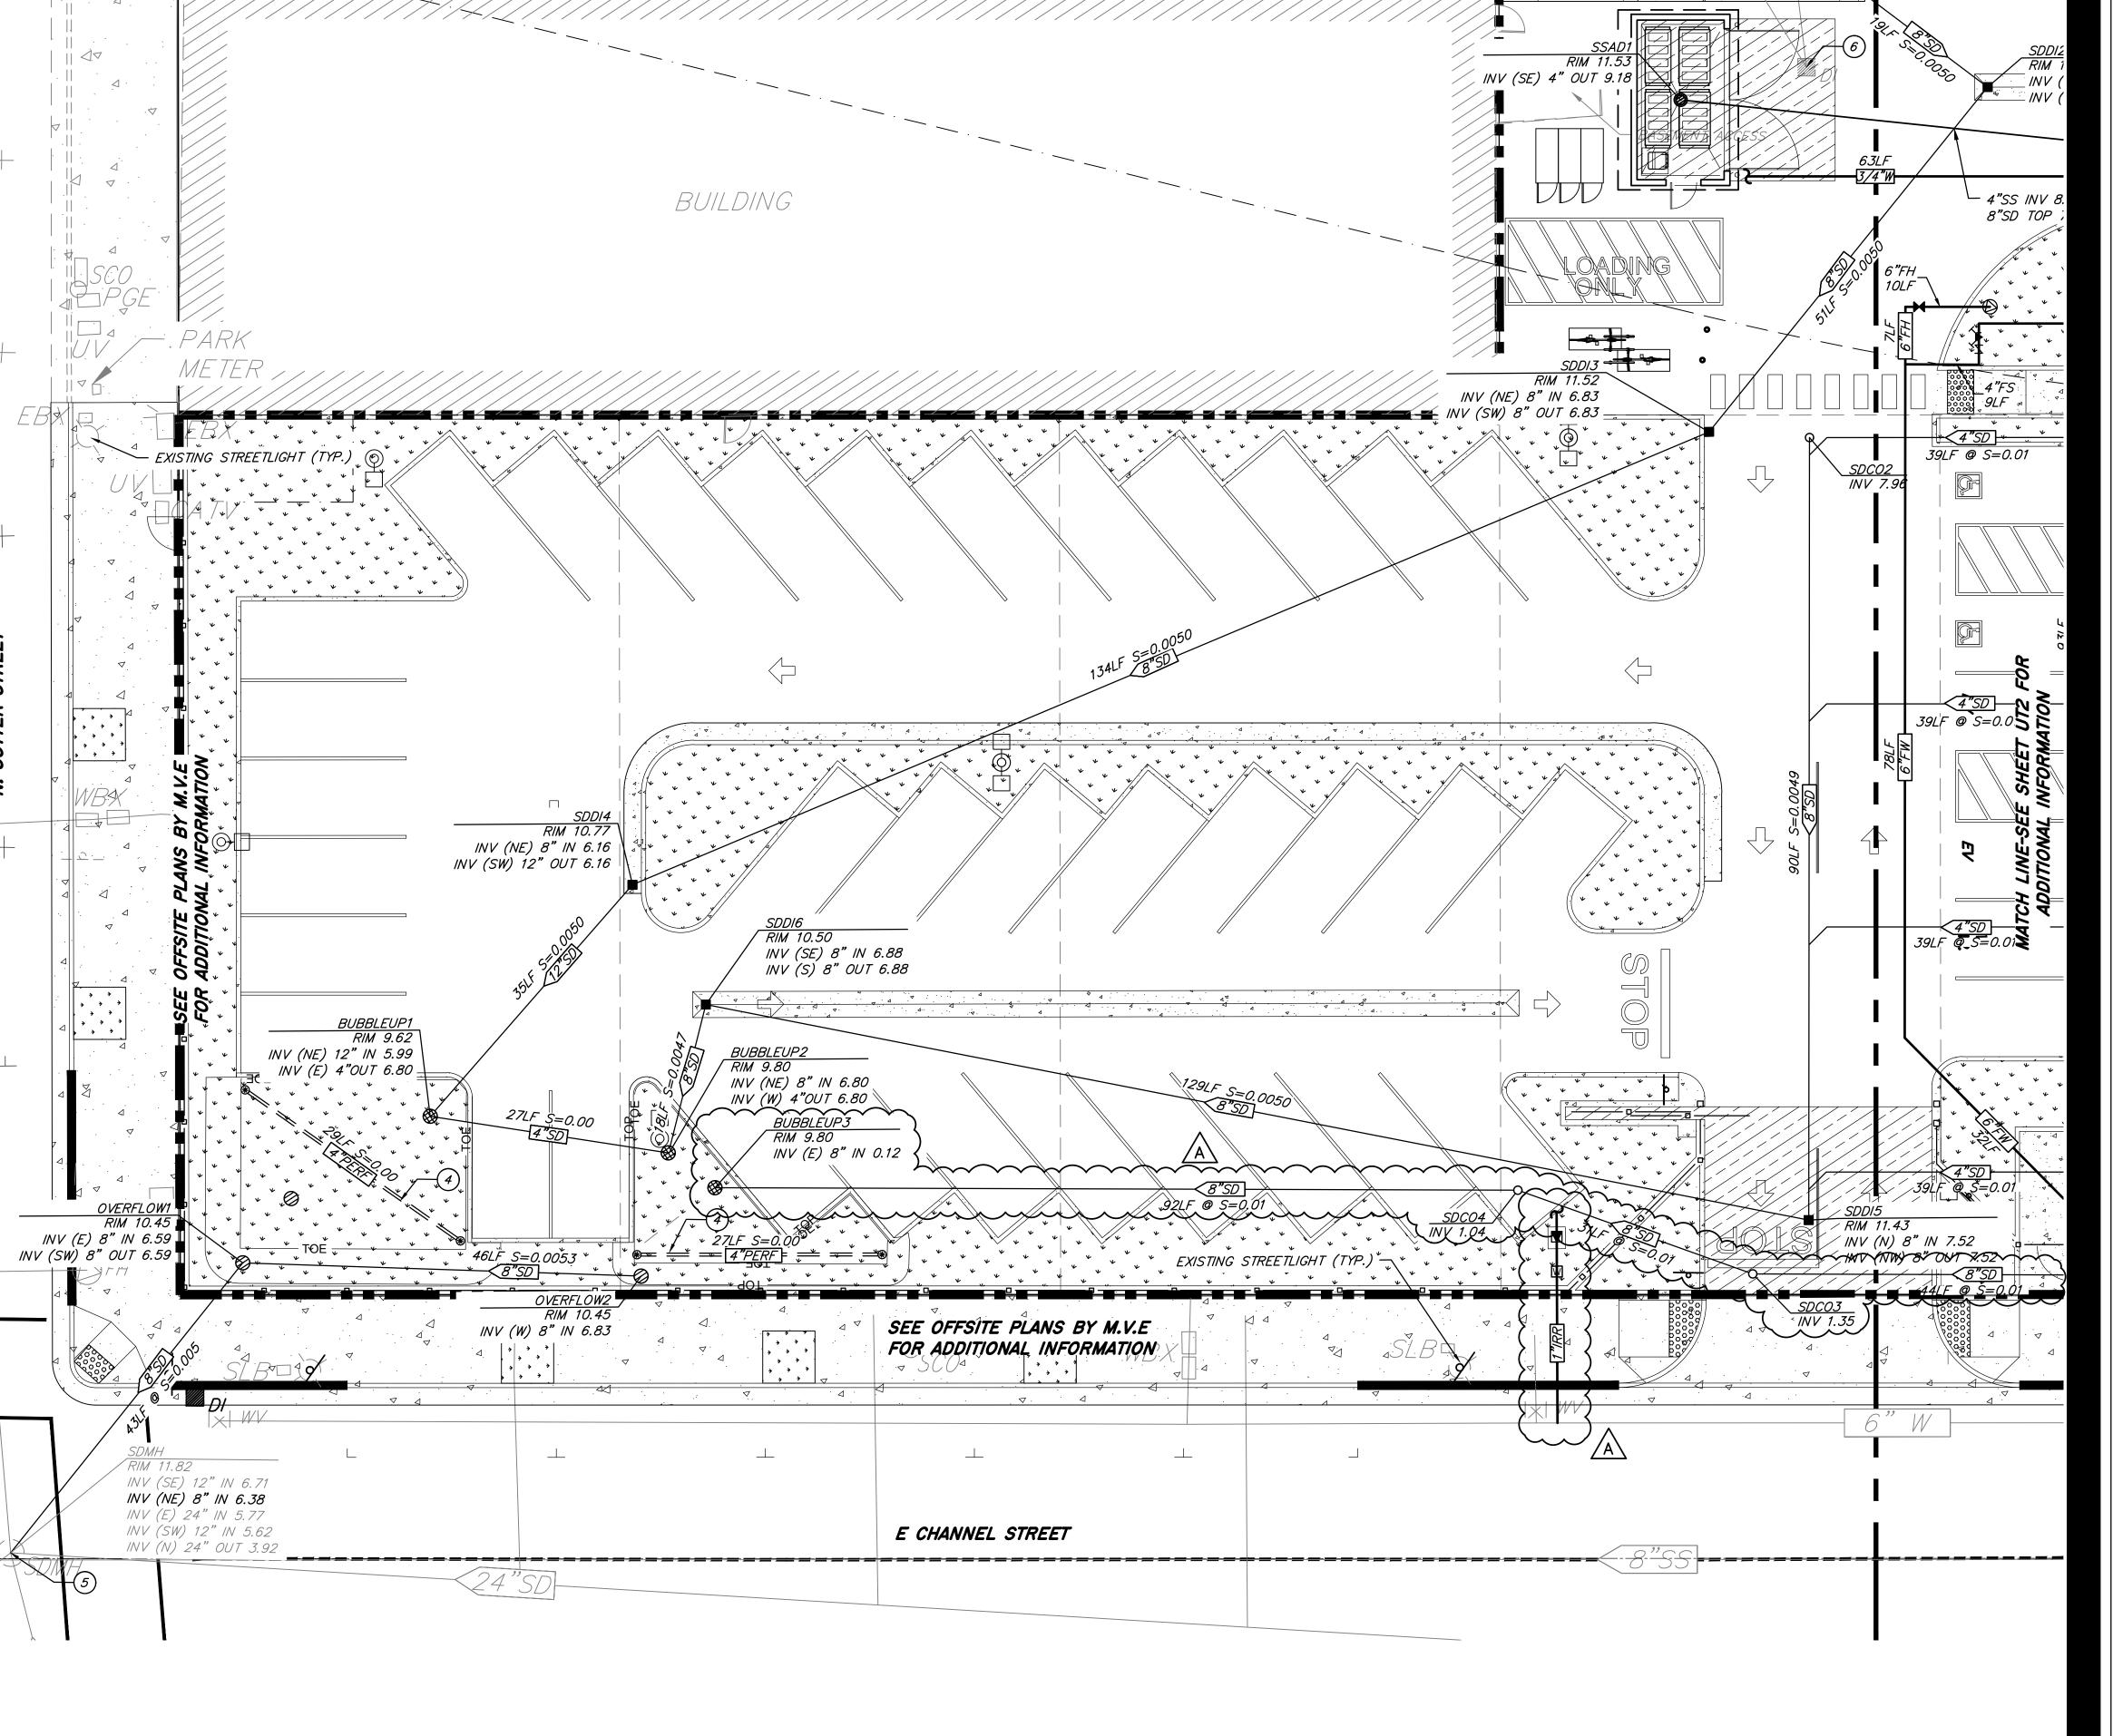



PRIOR TO CONSTRUCTION THE CONTRACTOR SHALL CALL UNDERGROUND SERVICE ALERT FOR UNDERGROUND CLEARANCE. USA WILL PROVIDE INFORMATION ABOUT OR LOCATE AND MARK UNDERGROUND FACILITIES.

## UNAUTHORIZED CHANGES & USES

THE ENGINEER PREPARING THESE PLANS WILL NOT BE RESPONSIBLE FOR, OR LIABLE FOR, UNAUTHORIZED CHANGES TO OR USES OF THESE PLANS. ALL CHANGES TO THE PLANS MUST BE IN WRITING AND MUST BE APPROVED BY THE PREPARER OF THESE PLANS.



INV (SE) 8" OUT 7.59

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CODESTACK ACADEMY

201 N CALIFORNIA ST, STOCKTON, CA 95202

SAN JOAQUIN COUNTY OFFICE OF EDUCATION

REVISIONS	08/13/24
IN HOUSE REVISIONS	08/30/24
CODESTACK REQUESTED REV	08/30/24
STOCKTON SITE PLAN REVIEW	9/11/24
INTERWEST PC REVIEW	9/12/24
STOCKTON FIRE REVIEW	9/16/24
A ADDENDA #3	11/27/24
PROJECT NO: 2023-04 MVE NO: NC22297	


PROJECT NO: 2023-04, MVE NO: NC22297 ISSUE SET: DESIGN DEV.

ISSUE SET: DESIGN DEV.
ISSUE DATE: 10/30/2024

COMPOSITE UTILITY PLAN

DRAWN BY: DAM

UT1

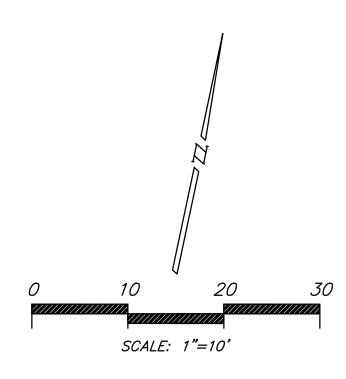

### **LEGEND**

- (INSTALL FIRE HYDRANT PER C.O.S. STD. DWG. W-13.
- INSTALL REDUCED PRESSURE BACKFLOW PREVENTION ASSEMBLY PER CALIFORNIA WATER STANDARDS.
- **Ⅲ** INSTALL WATER METER PER CALIFORNIA WATER STANDARDS.
- INSTALL SINGLE CHECK AND FIRE DEPARTMENT CONNECTION.
  PER C.O.S. STD. DWG. W-17.
- INSTALL REDUCED PRESSURE PRINCIPLE DETECTOR ASSEMBLY PER CALIFORNIA WATER STANDARDS.
- INSTALL AREA DRAIN. SEE SHEET CD1 FOR DETAIL.
- ∅ INSTALL OVERFLOW STRUCTURE, SEE SHEET CD1 FOR DETAIL.
- O INSTALL STORM DRAIN CLEANOUT, SEE SHEET CD1 FOR DETAIL.
- INSTALL SEWER AREA DRAIN, SEE SHEET CD1 FOR DETAIL.
- INSTALL SEWER CLEANOUT, SEE SHEET CD1 FOR DETAIL.

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SANITARY SEWER NOTES


- SEWER POINT OF CONNECTION (P.O.C) TO BE 5' FROM BUILDING. FOR CONTINUATION, SEE PLUMBING PLANS BY OTHERS FOR ADDITIONAL INFORMATION. CONNECT TO THE BUILDING WITH 4" P.V.C. USE ELBOWS AS NECESSARY TO MEET BUILDING SEWER INVERTS. VERIFY FINAL LOCATION WITH PLUMBING PLANS BY OTHERS
- (2) CONTRACTOR TO POT HOLE AND VERIFY THE INVERT PRIOR TO CONSTRUCTION.
- CONTRACTOR TO OBTAIN A ENCROACHMENT PERMIT FROM CITY PRIOR TO CONSTRUCTION.

## STORM DRAIN NOTES

- CONTRACTOR TO INSTALL 4" PERFORATED PIPE, SEE SHEET CD1 FOR
- 5 4" PIPE BY OTHERS. SEE ARCHITECTURAL PLANS FOR ADDITIONAL INFORMATION.
- CONTRACTOR TO ADJUST STRUCTURE TO GRADE. INSTALL TRAFFIC RATED SOLID COVER.

### WATER NOTES

- (7) WATER SERVICE POINT OF CONNECTION (P.O.C) TO BE 5' FROM BUILDINGS. FOR CONTINUATION, SEE PLUMBING PLANS BY OTHERS FOR ADDITIONAL INFORMATION.
- FIRE WATER SPRINKLER SERVICE POINT OF CONNECTION (P.O.C) TO 8) BE 5' FROM BUILDING. FOR CONTINUATION, SEE FIRE SPRINKLER PLANS BY OTHERS FOR ADDITIONAL INFORMATION.

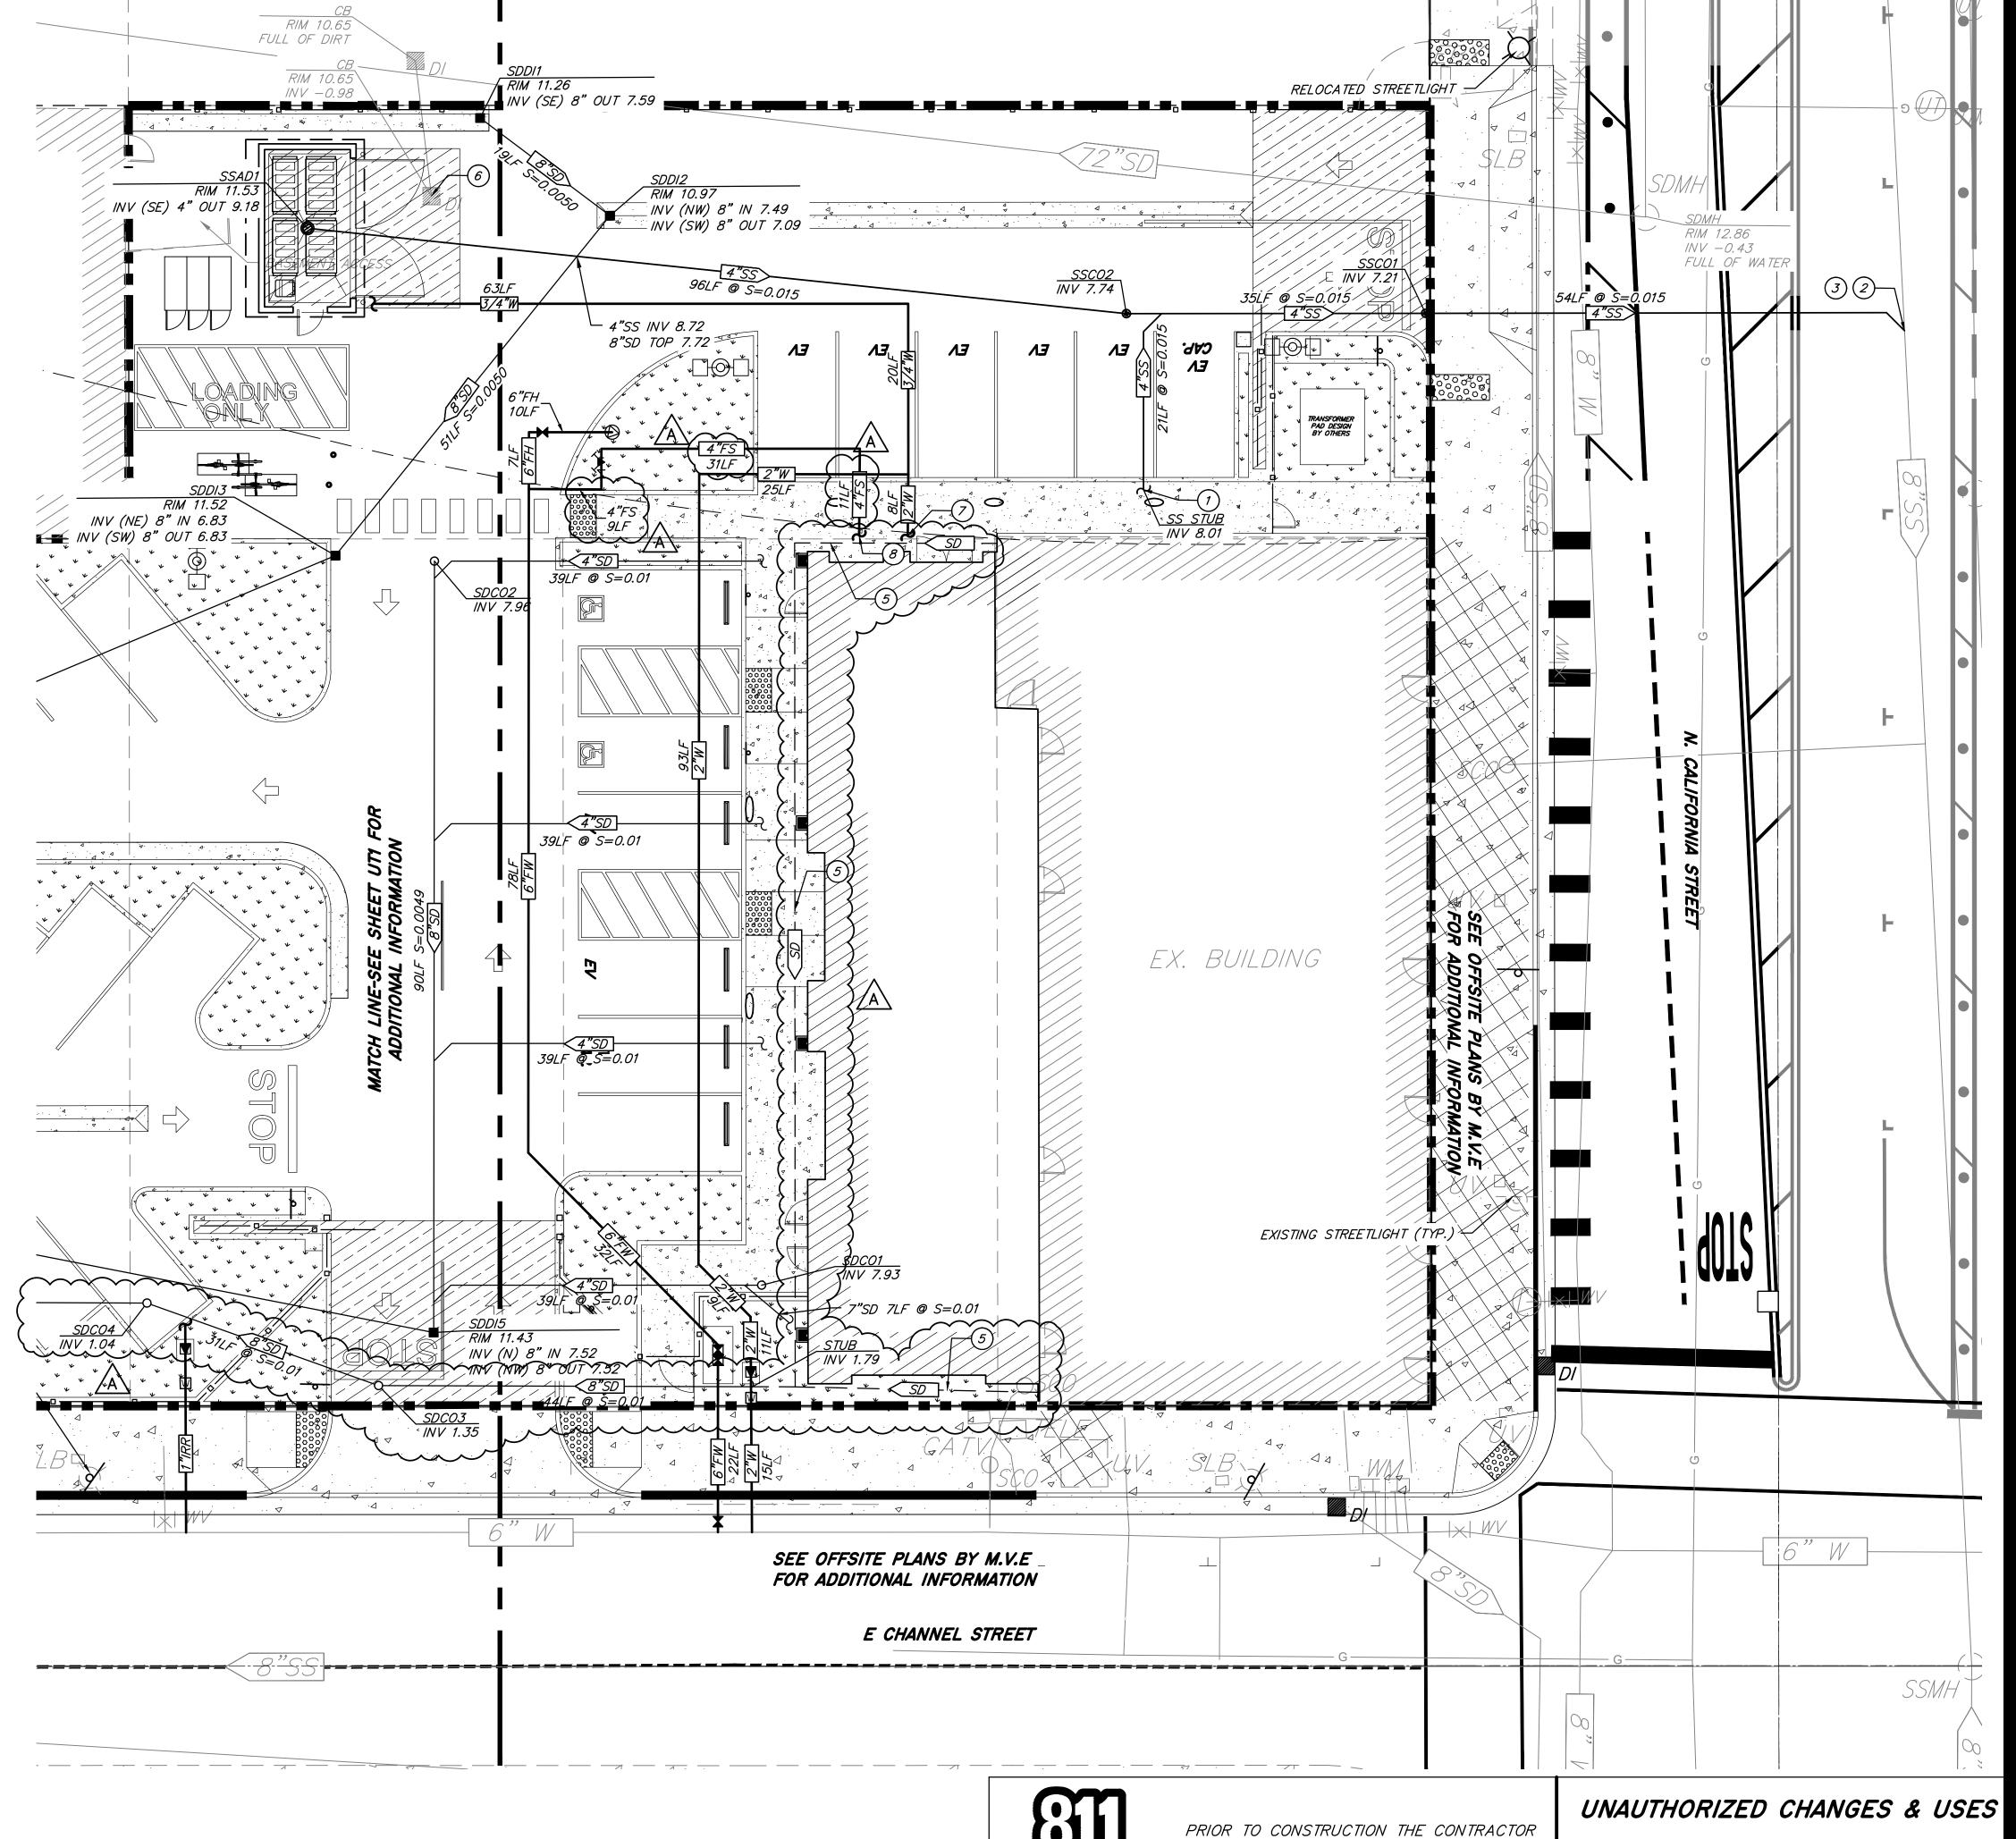

Know what's below.

Call before you dig.

THE ENGINEER PREPARING THESE PLANS WILL NOT BE RESPONSIBLE FOR, OR LIABLE FOR, UNAUTHORIZED CHANGES TO OR USES OF THESE PLANS. ALL CHANGES TO THE PLANS MUST BE IN WRITING AND MUST BE APPROVED BY THE PREPARER OF THESE PLANS.

SHALL CALL UNDERGROUND SERVICE ALERT

FOR UNDERGROUND CLEARANCE. USA WILL

PROVIDE INFORMATION ABOUT OR LOCATE

AND MARK UNDERGROUND FACILITIES.



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MVE Inc. 1117 L Street, Modesto, CA 95354 866.526.4214 | www.mve.net Northem Calif<mark>a</mark>nia | Southem California | Nevada



CODESTACK **ACADEMY** 

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SAN JOAQUIN COUNTY OFFICE OF EDUCATION


REVISIONS IN HOUSE REVISIONS 08/13/24 2 CODESTACK REQUESTED REV 08/30/24 3 STOCKTON SITE PLAN REVIEW 9/11/24 4 INTERWEST PC REVIEW 9/12/24 5 STOCKTON FIRE REVIEW 9/16/24 A ADDENDA #3 PROJECT NO: 2023-04, MVE NO: NC22297

ISSUE SET: DESIGN DEV.

ISSUE DATE: 10/30/2024 DRAWN BY: DAM


COMPOSITE **UTILITY PLAN** 

UT2

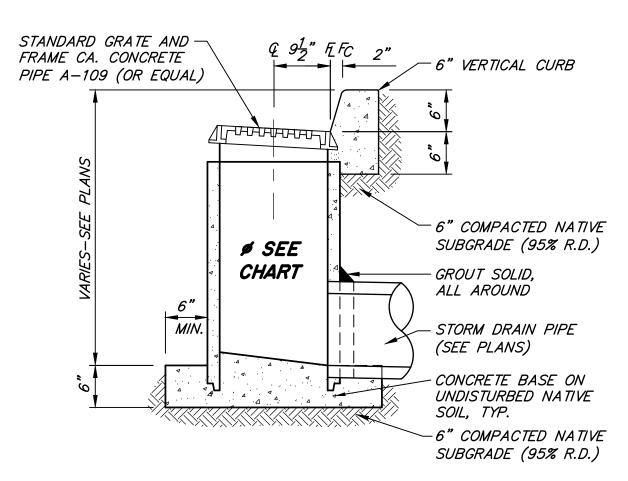

## AREA DRAIN IN VERTICAL CURB

- STANDARD GRATE AND FRAME CA. CONCRETE PIPE A-109 (OR EQUAL).

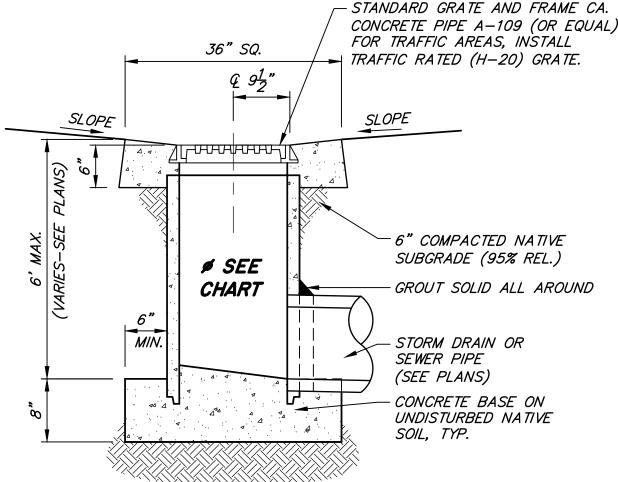


## TYPICAL AREA DRAIN


CAST IRON GRATE & ANGLE, -NEENAH FOUNDRY SERIES R4370 OR APPROVED EQUAL - RIM PER PLAN ø see -GROUT SOLID ALL AROUND CHART STORM DRAIN PIPE (SEE PLANS) MIN CONCRETE BASE ON UNDISTURBED

## OVERFLOW INLET

NATIVE SOIL, TYP.

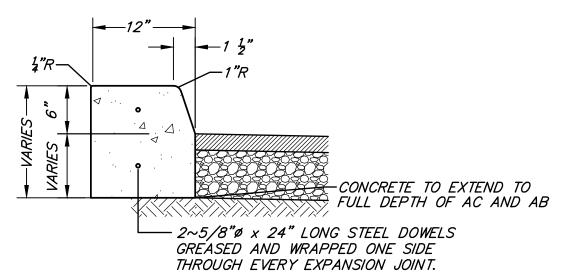


12" WIDE VERTICAL CURB

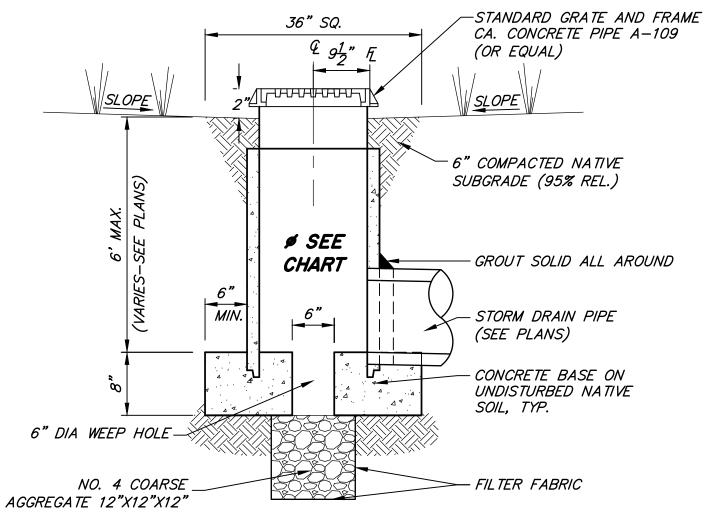


## BUBBLE-UP STRUCTURE

VERTICAL RCP RISER DIAMETER	LATERAL RCP MAX PIPE DIAMETER
18"	8"
24"	12"
<i>30"</i>	18"
<i>36"</i>	24"
42"	<i>30"</i>


## SIZING CHART

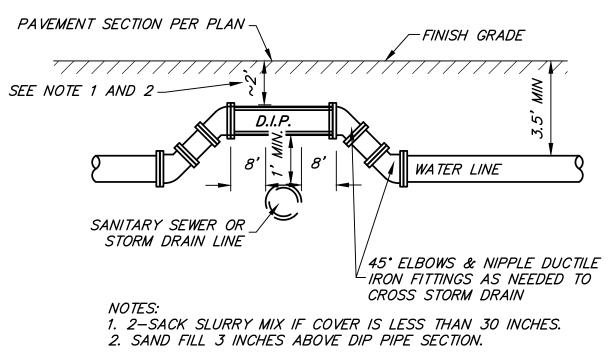


## TYPICAL WATER CROSSING DETAIL NTS

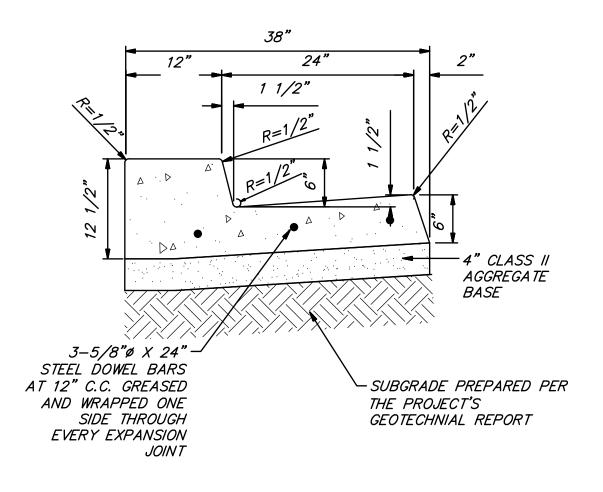


12" WIDE CURB AND GUTTER

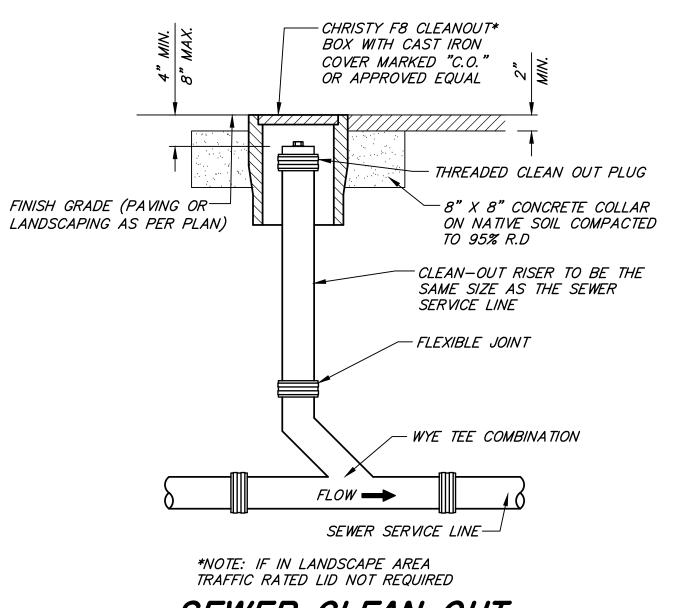


## SEWER CLEAN OUT

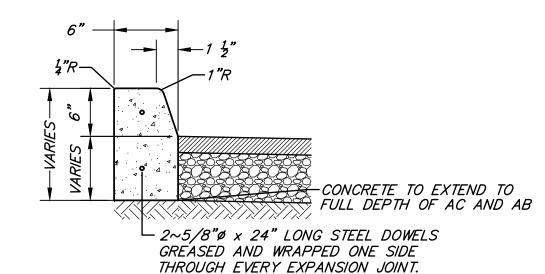


6" VERTICAL CURB

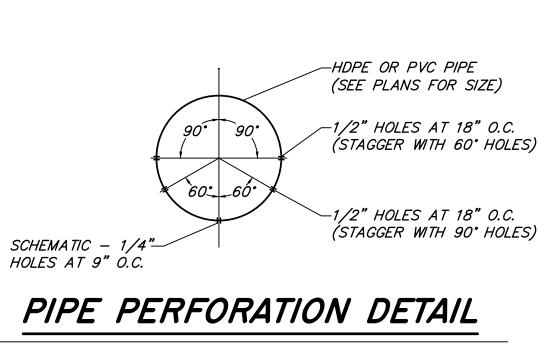

NTS

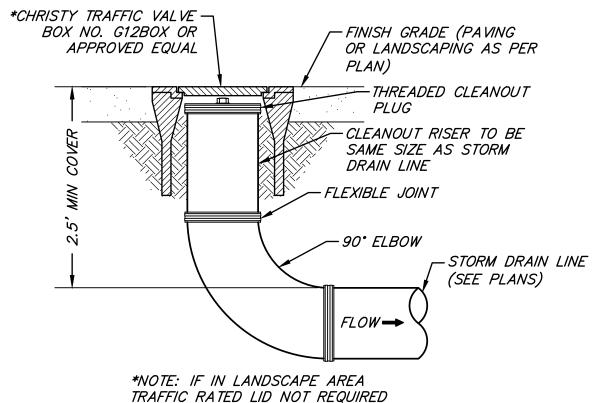

STORM DRAIN CLEANOUT

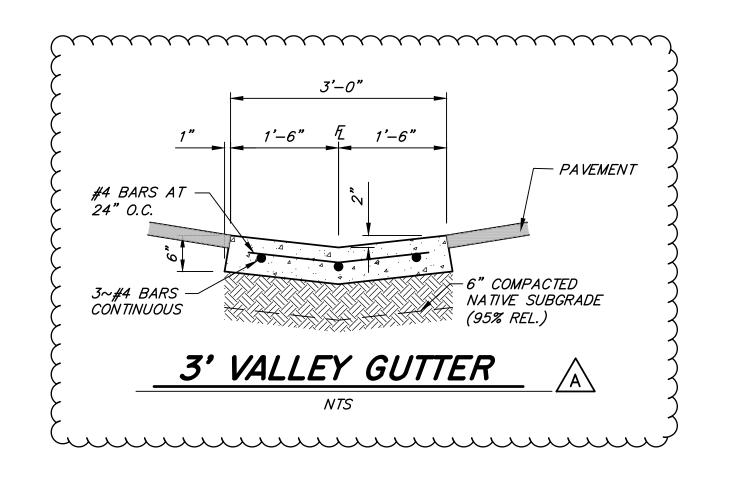



PRIOR TO CONSTRUCTION THE CONTRACTOR SHALL CALL UNDERGROUND SERVICE ALERT FOR UNDERGROUND CLEARANCE. USA WILL PROVIDE INFORMATION ABOUT OR LOCATE AND MARK UNDERGROUND FACILITIES.

## UNAUTHORIZED CHANGES & USES

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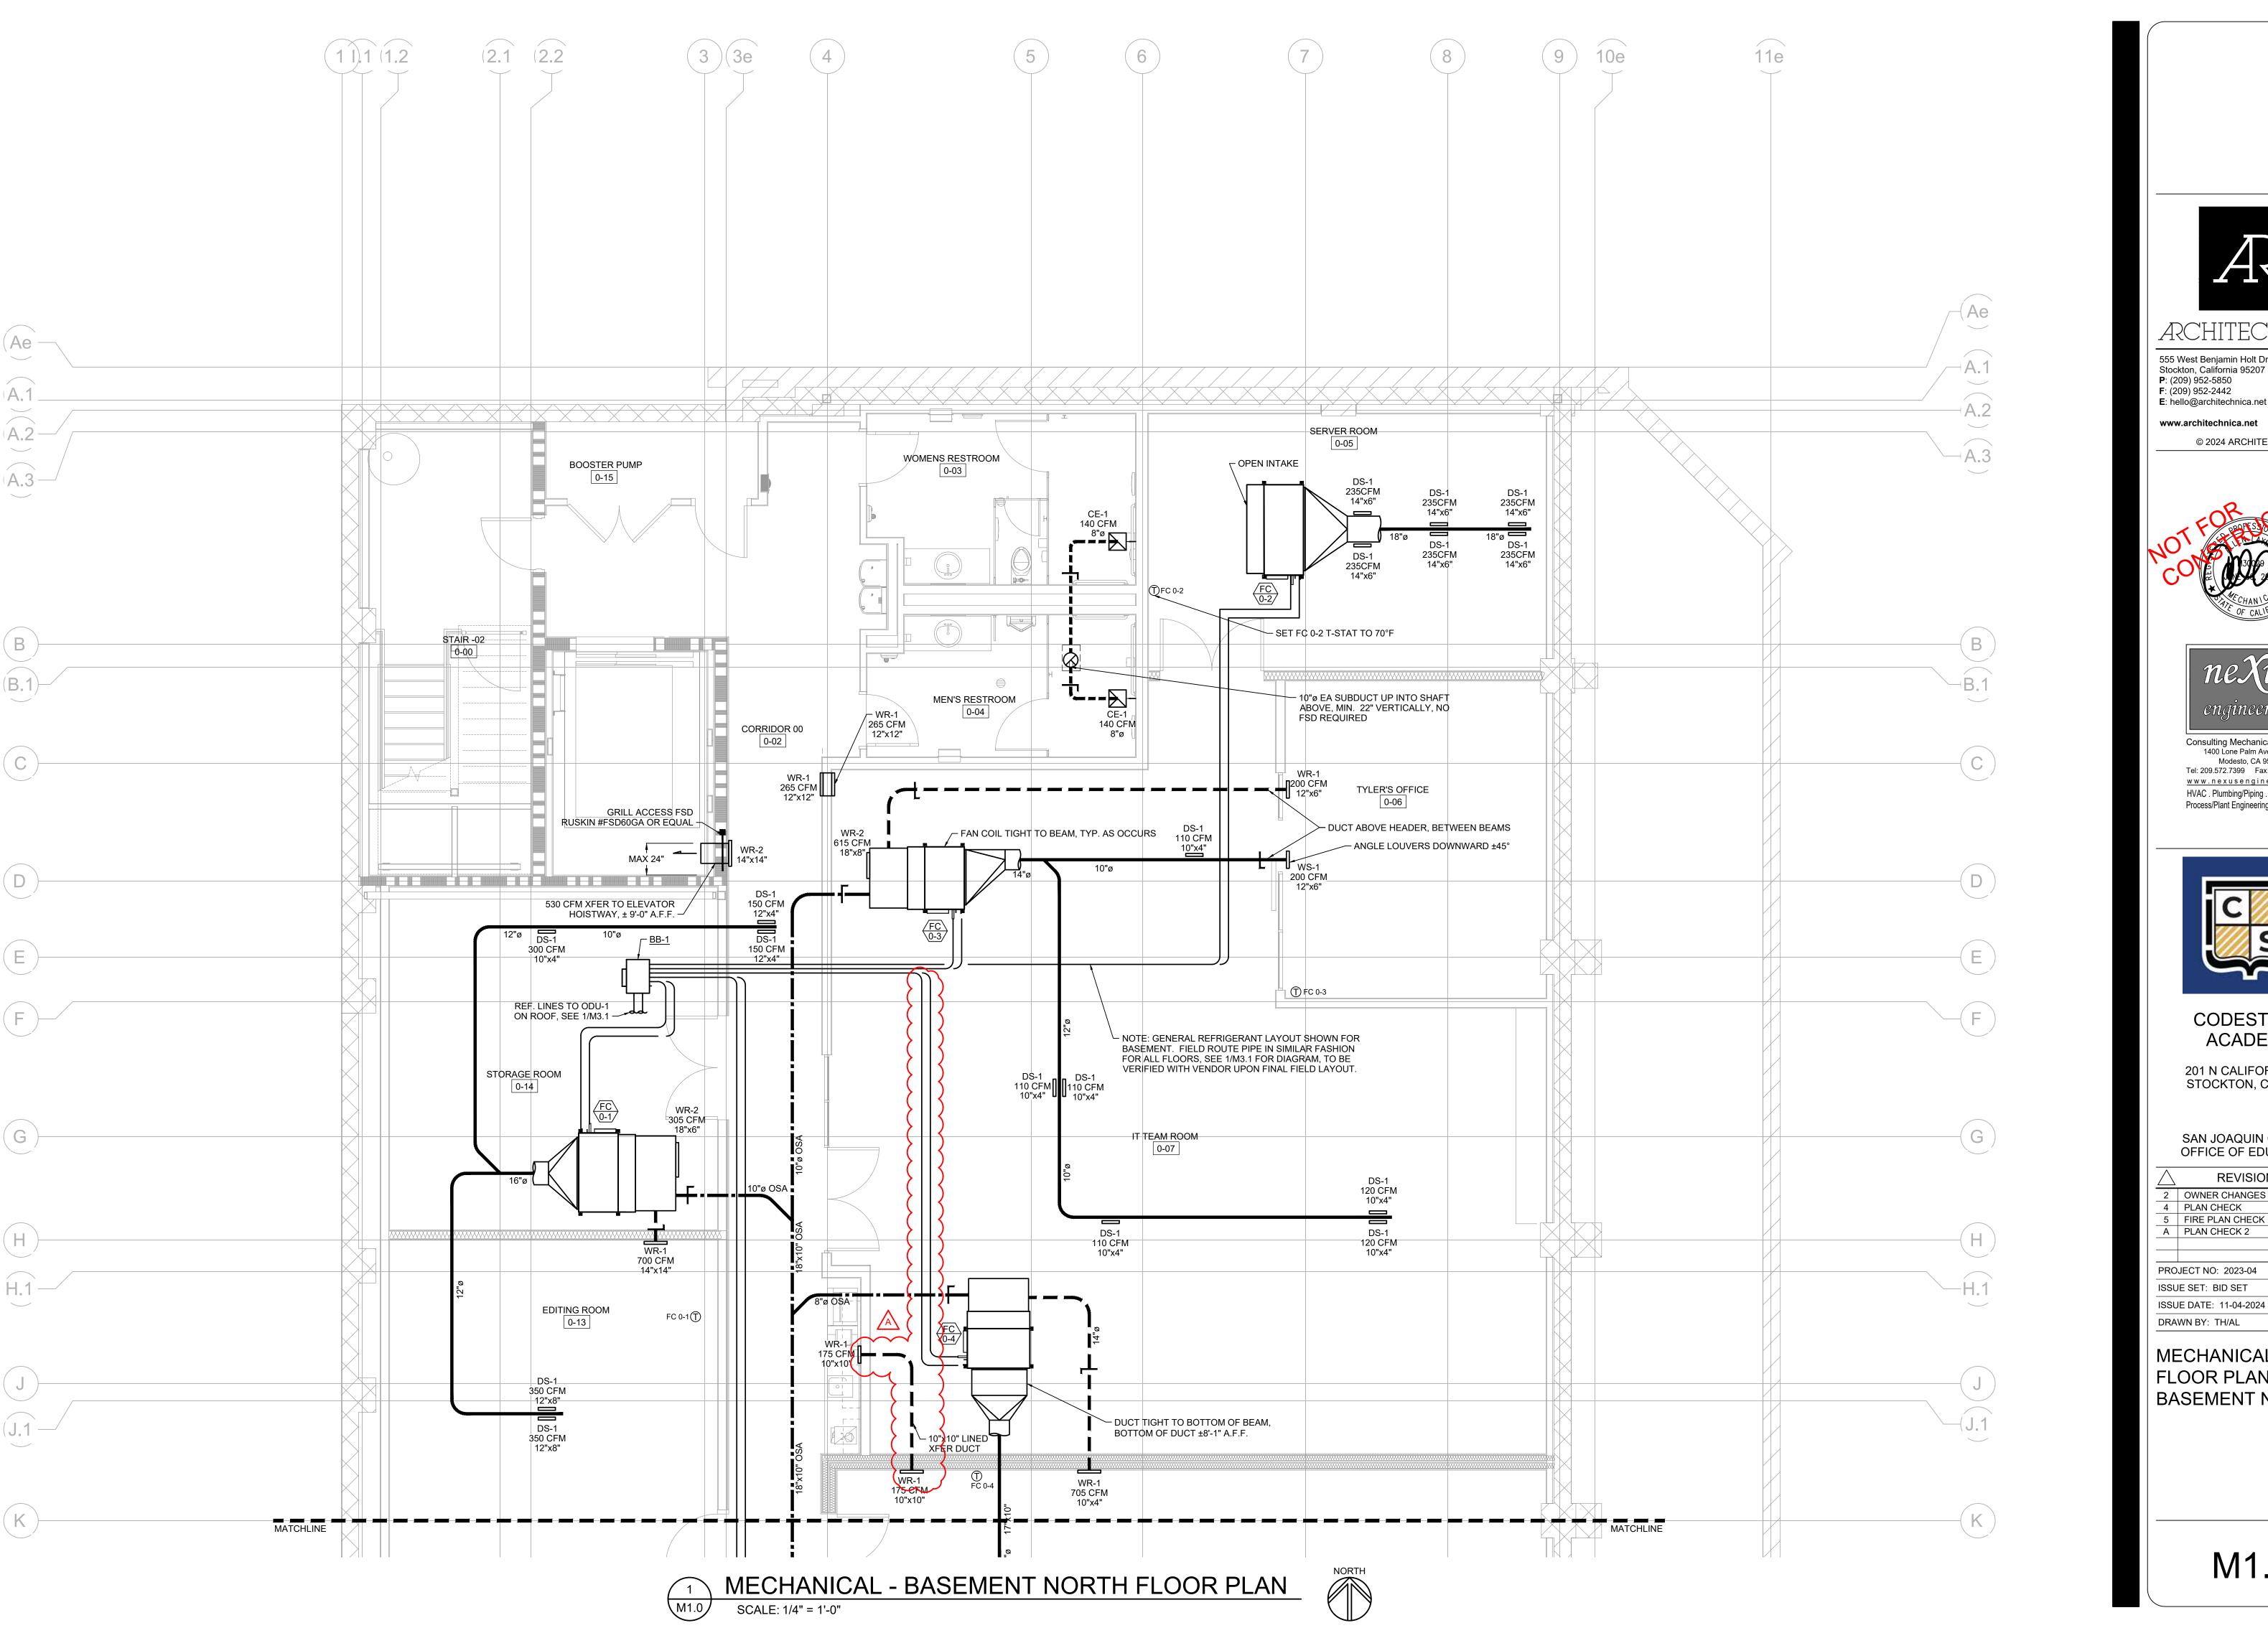
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SAN JOAQUIN COUNTY OFFICE OF EDUCATION

$\triangle$	REVISIONS			
1	IN HOUSE REVISIONS	08/13/24		
2	CODESTACK REQUESTED REV	08/30/24		
3	STOCKTON SITE PLAN REVIEW	9/11/24		
4	INTERWEST PC REVIEW	9/12/24		
5	STOCKTON FIRE REVIEW	9/16/24		
Α	ADDENDA #3	11/27/24		
PROJECT NO: 2023-04, MVE NO: NC22297				
ISSUE SET: DESIGN DEV.				

ISSUE DATE: 10/30/2024 DRAWN BY: DAM

CONSTRUCTION **DETAILS** 



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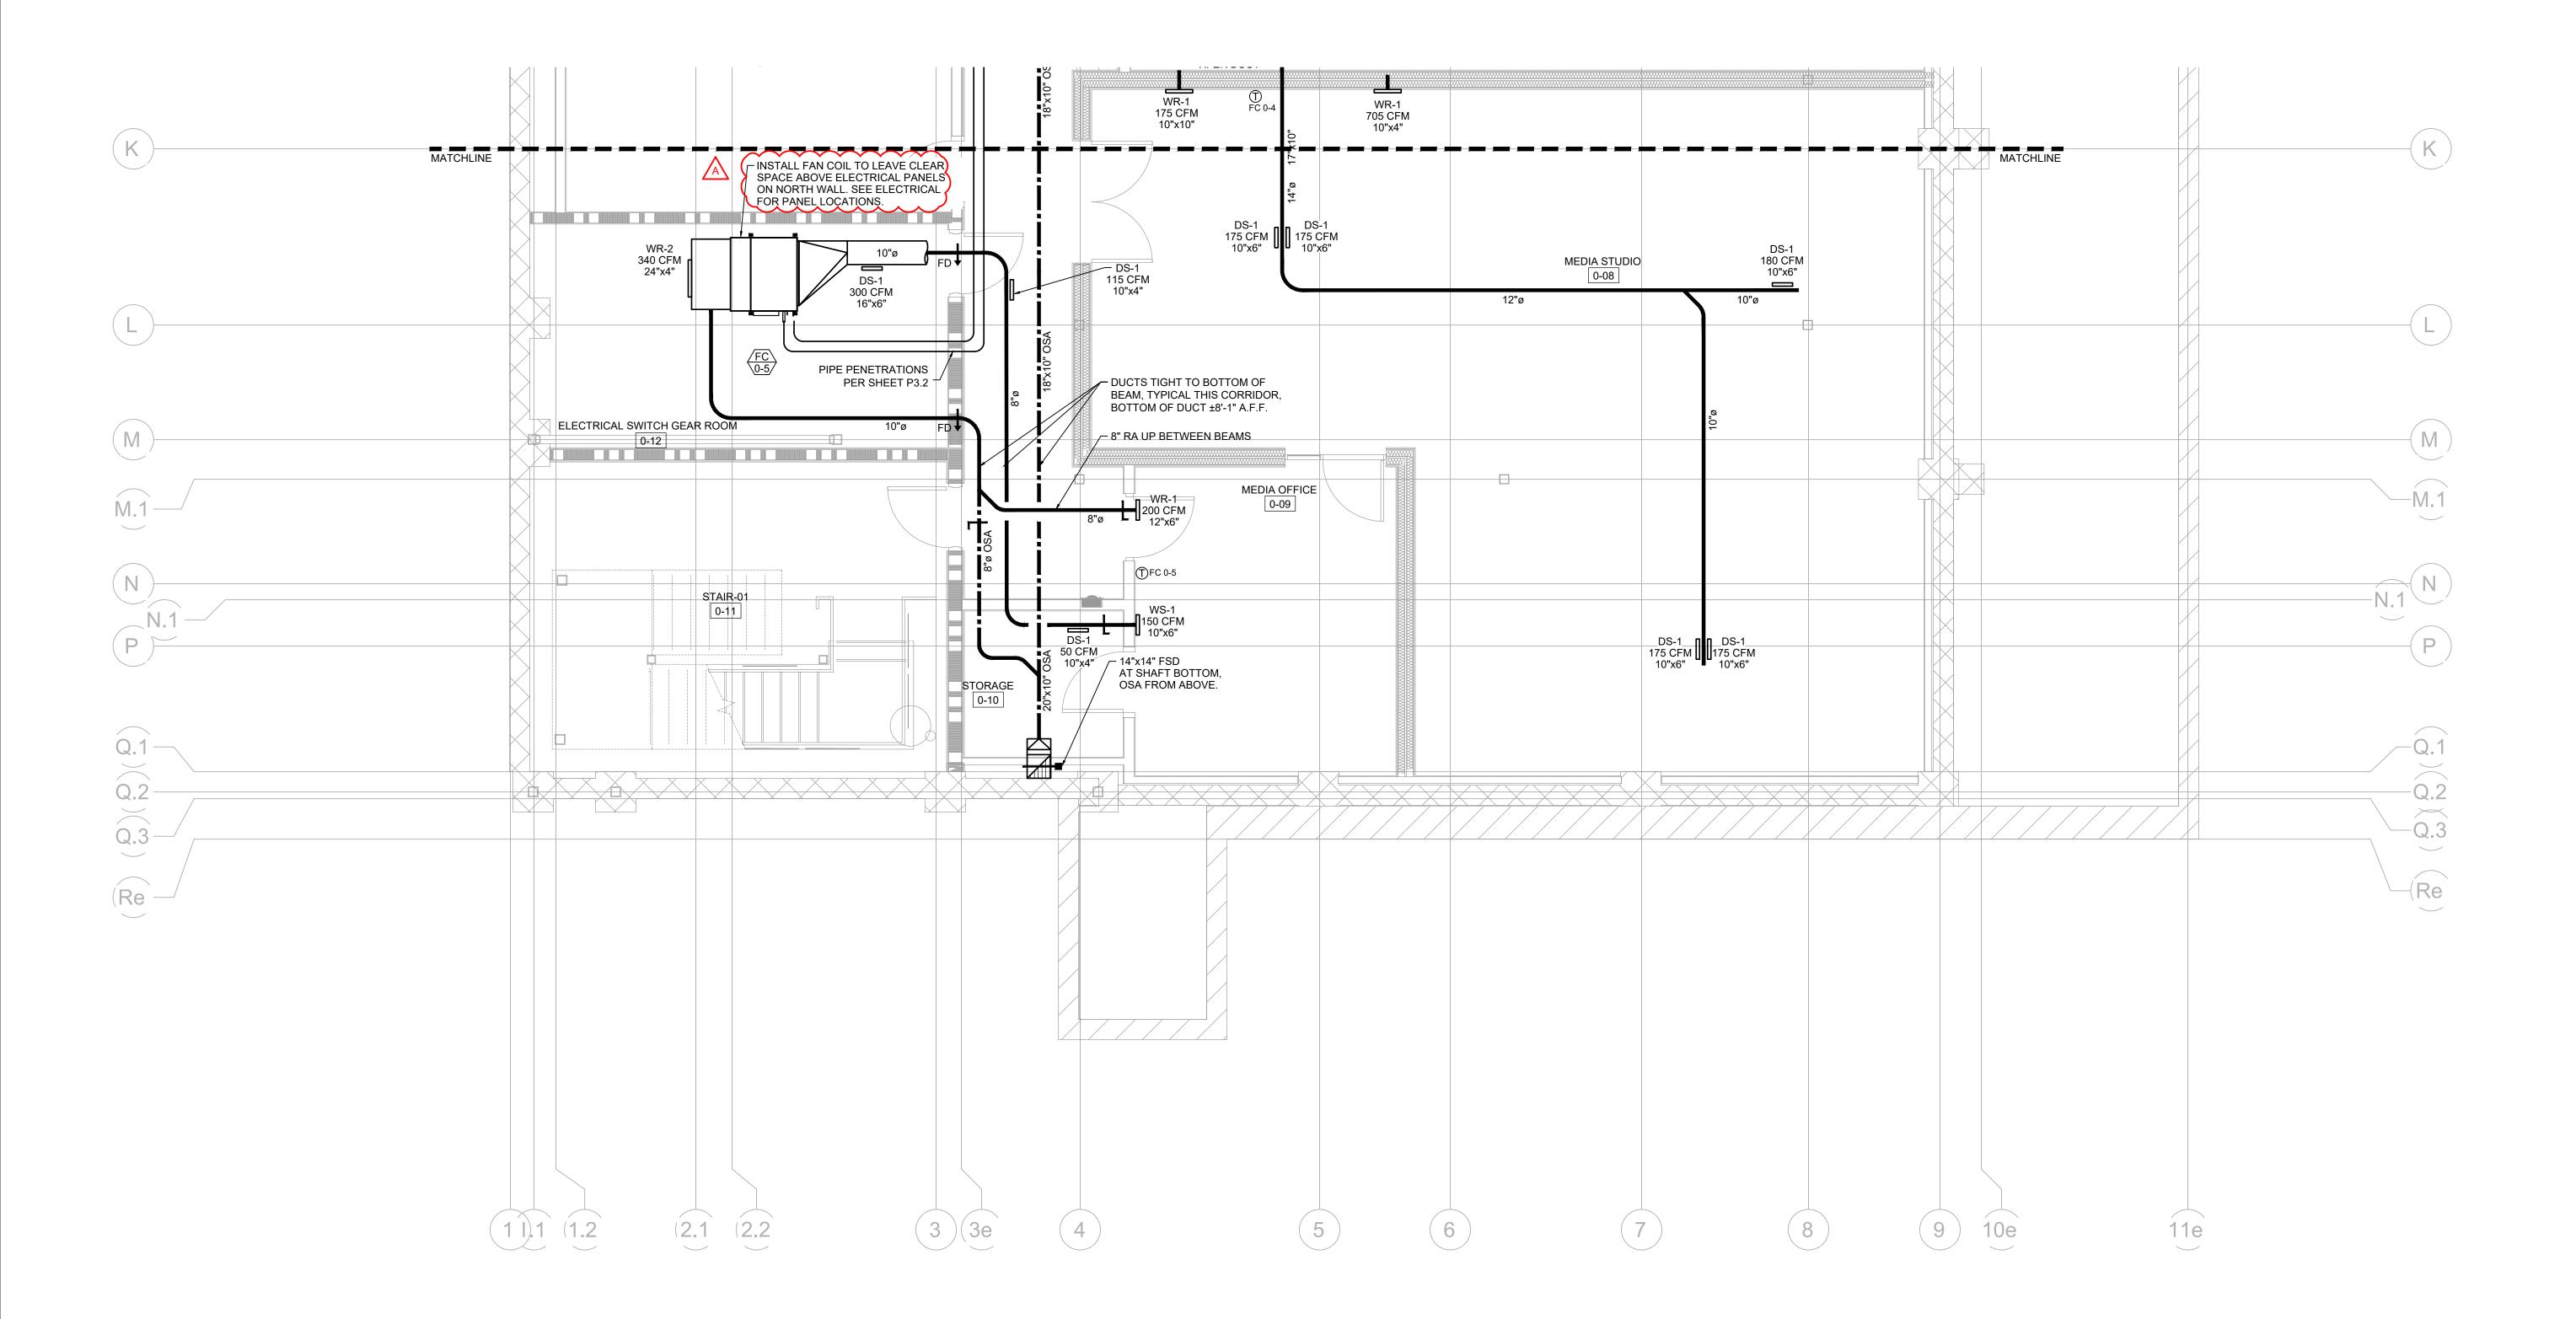
SAN JOAQUIN COUNTY

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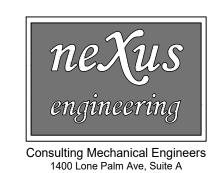
OFFICE OF EDUCATION					
REVISIONS					
2	OWNER CHANGES	08/30/24			
4	PLAN CHECK	08/13/24			
5	FIRE PLAN CHECK	08/13/24			
Α	PLAN CHECK 2	11/25/24			
PROJECT NO: 2023-04					
ISSUE SET: BID SET					

**MECHANICAL** FLOOR PLAN **BASEMENT NORTH** 

M1.0







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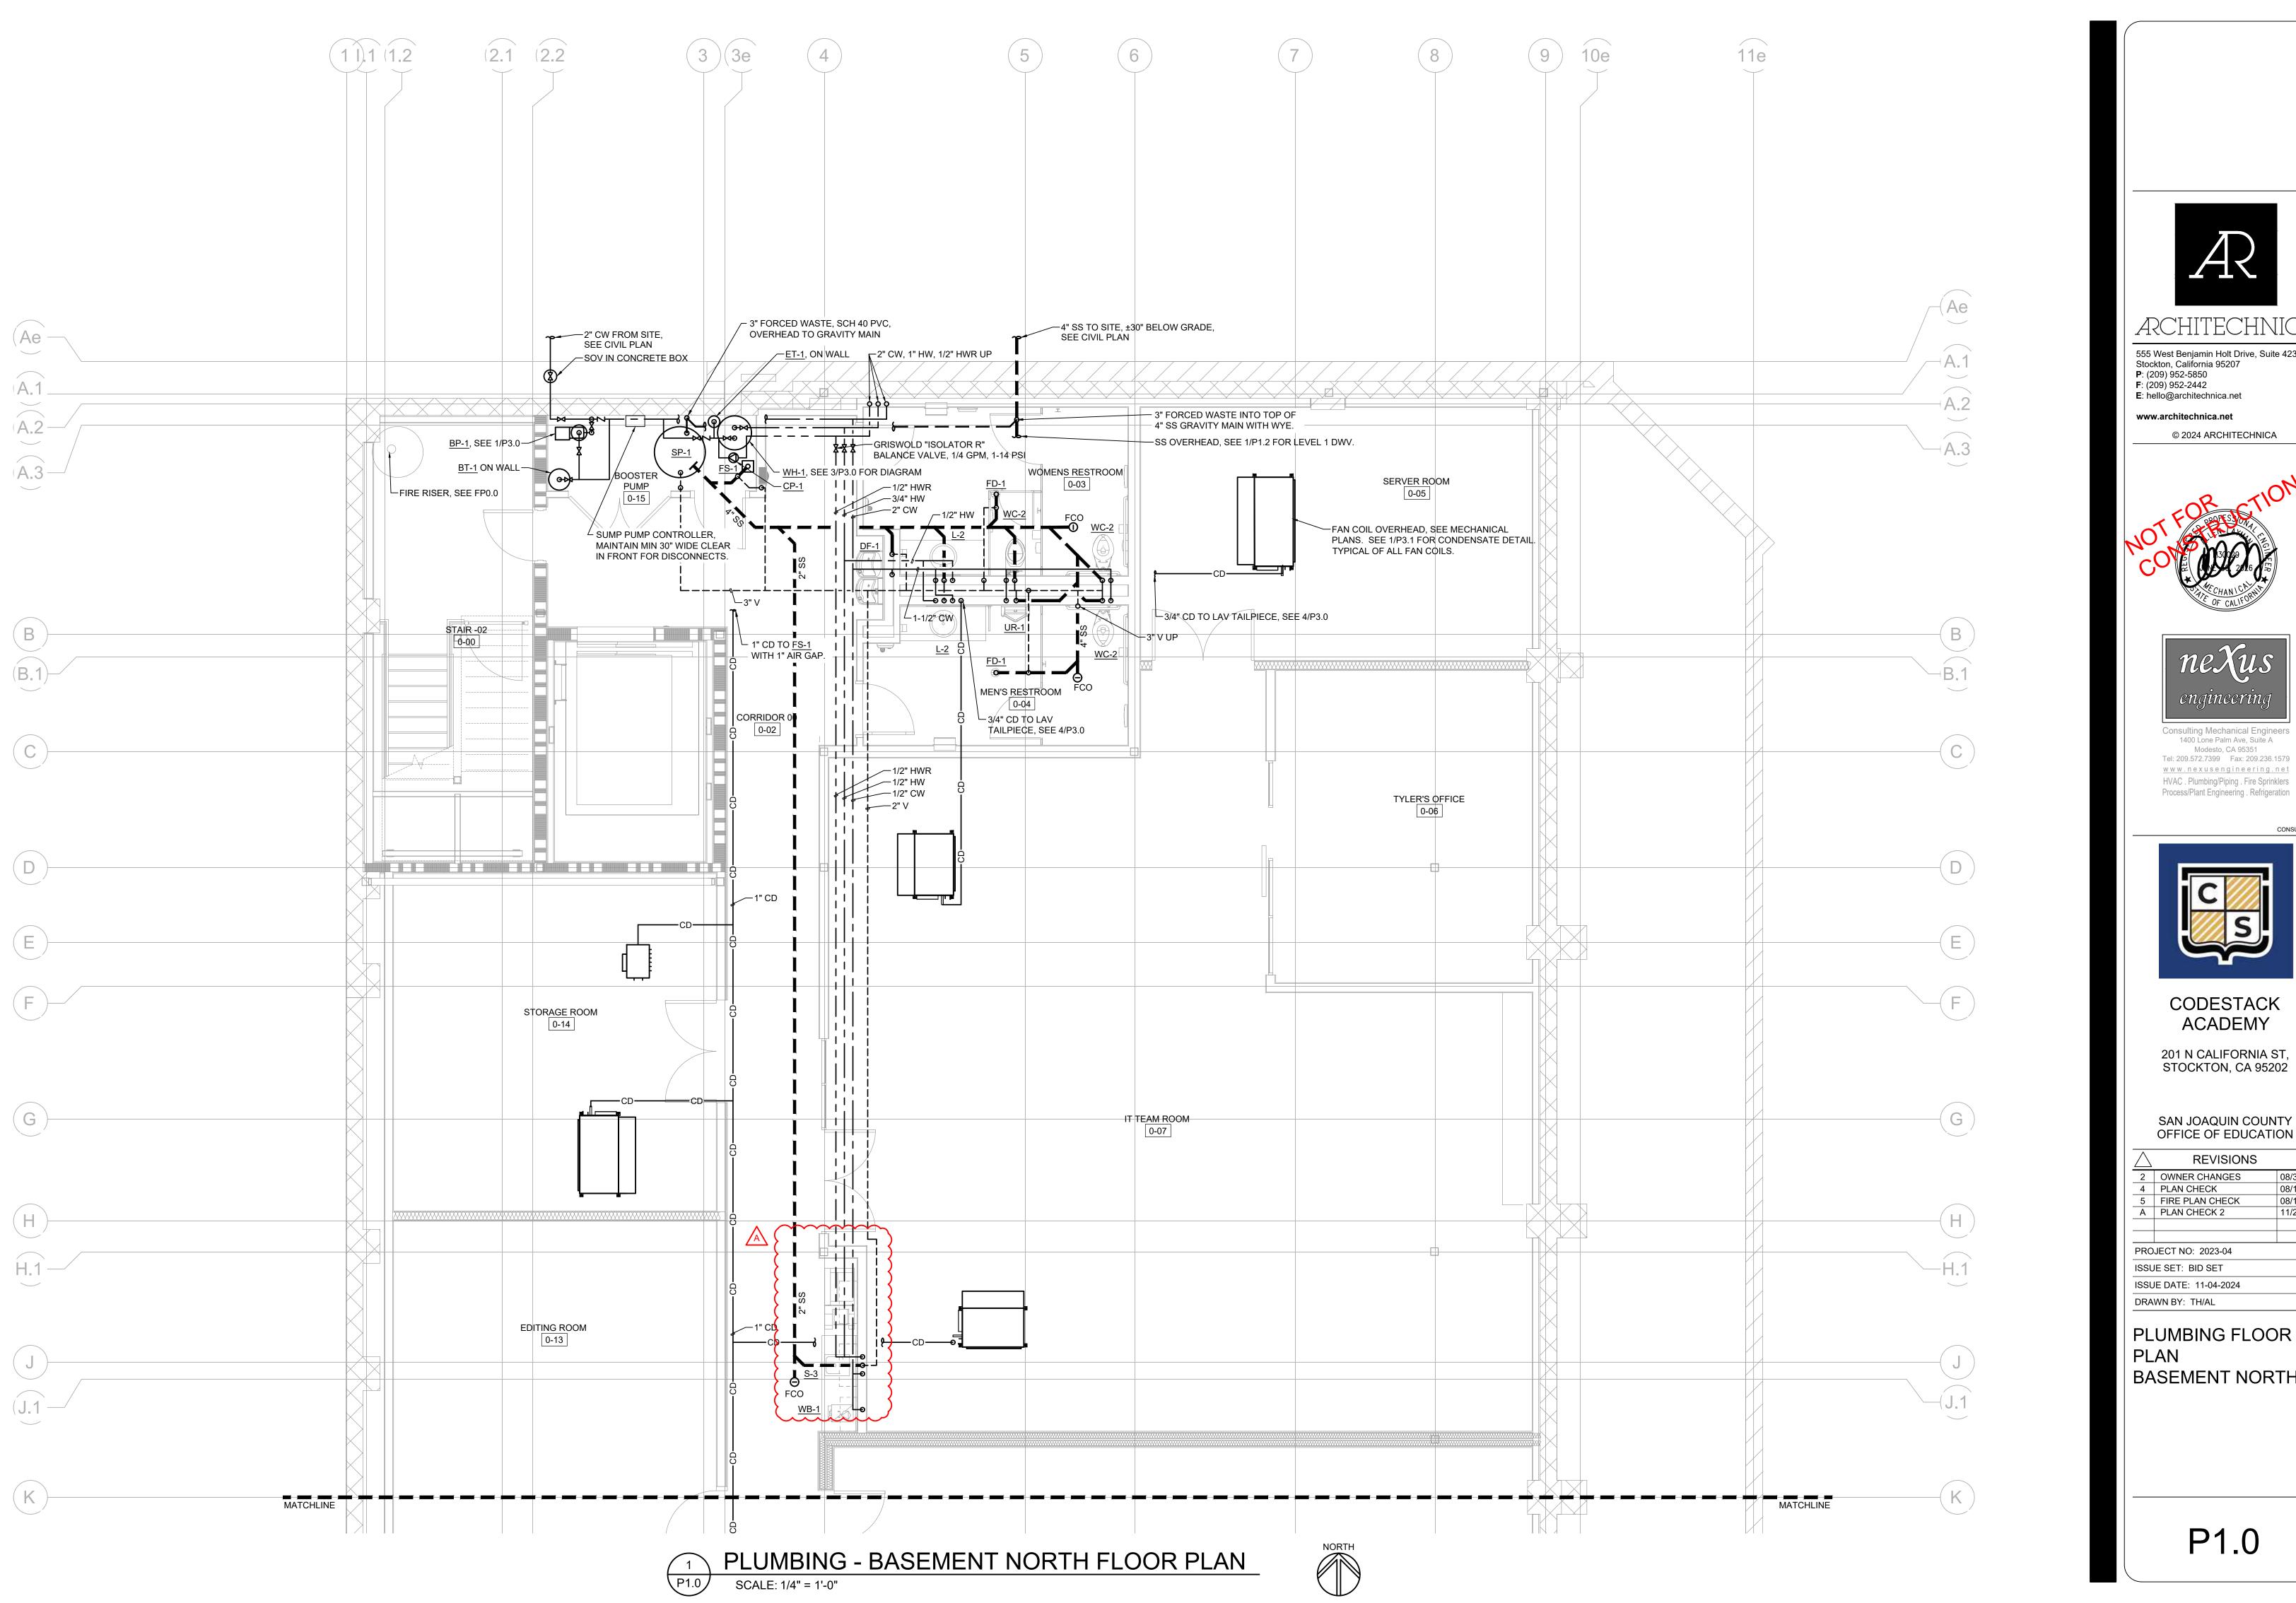
SAN JOAQUIN COUNTY OFFICE OF EDUCATION

	REVISIONS	
2	OWNER CHANGES	08/30
4	PLAN CHECK	08/13
5	FIRE PLAN CHECK	08/13
Α	PLAN CHECK 2	11/25
PRO	JECT NO: 2023-04	

ISSUE SET: BID SET ISSUE DATE: 11-04-2024 DRAWN BY: TH/AL


**MECHANICAL** FLOOR PLAN **BASEMENT SOUTH** 

M1.1



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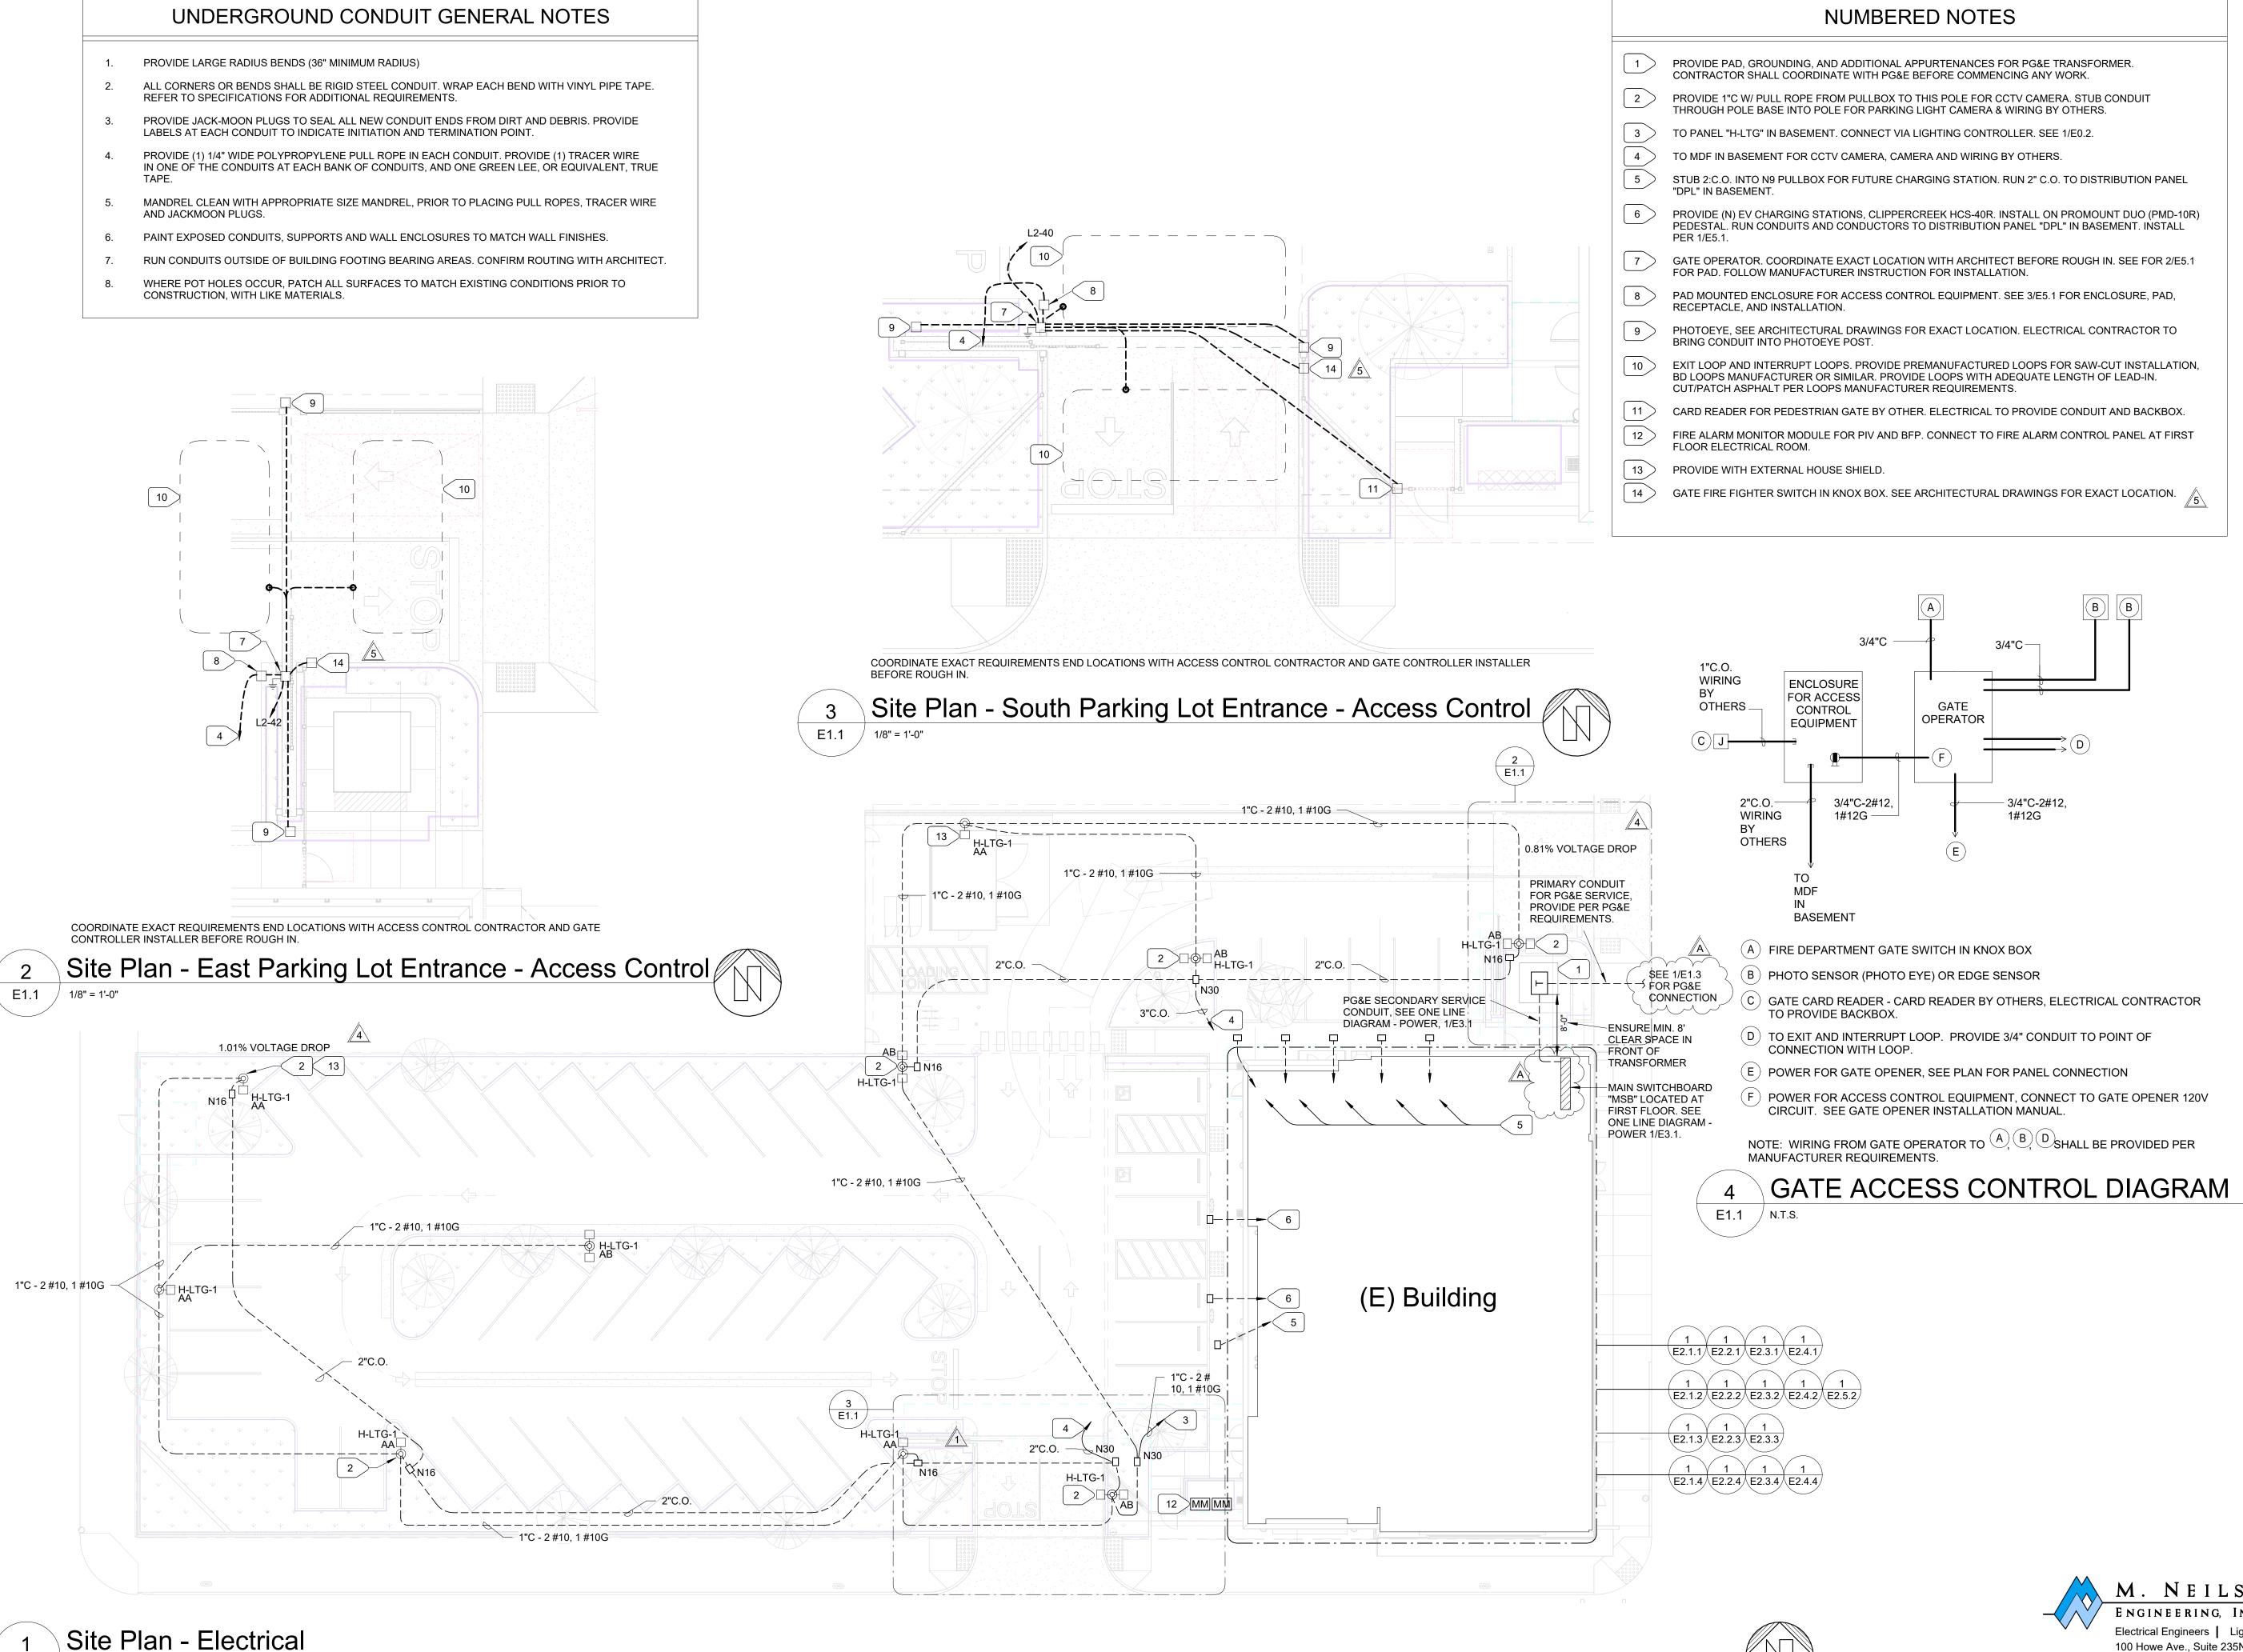
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08/30/24 08/13/24 11/25/24

**BASEMENT NORTH** 

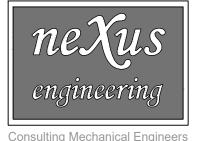

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SAN JOAQUIN COUNTY OFFICE OF EDUCATION

REVISIONS 1 In House Revisions 4 Interwest Plancheck Review Stockton Fire Review 11/25/24 A Interwest Corrections PROJECT NO: 23046.21

ISSUE SET: CD Drawings ISSUE DATE: 09-26-2024

DRAWN BY: BR


SITE PLAN -**ELECTRICAL** 

M. NEILS ENGINEERING, INC. Electrical Engineers | Lighting Designers 100 Howe Ave., Suite 235N Sacramento, CA 95825-8217 www.mneilsengineering.com

Tel: (916) 923-4400 PROJECT #: 23046.21


## **GENERAL NOTES**


- INFORMATION GIVEN ON THIS PLAN IS PRELIMINARY. CONTRACTOR SHALL OBTAIN PG&E ENGINEERING PLANS BEFORE START ANY CONSTRUCTION.
- COORDINATE ALL WORK WITH PG&E AND ARCHITECT.
- REFER TO PG&E GREEN BOOK FOR REQUIREMENTS.

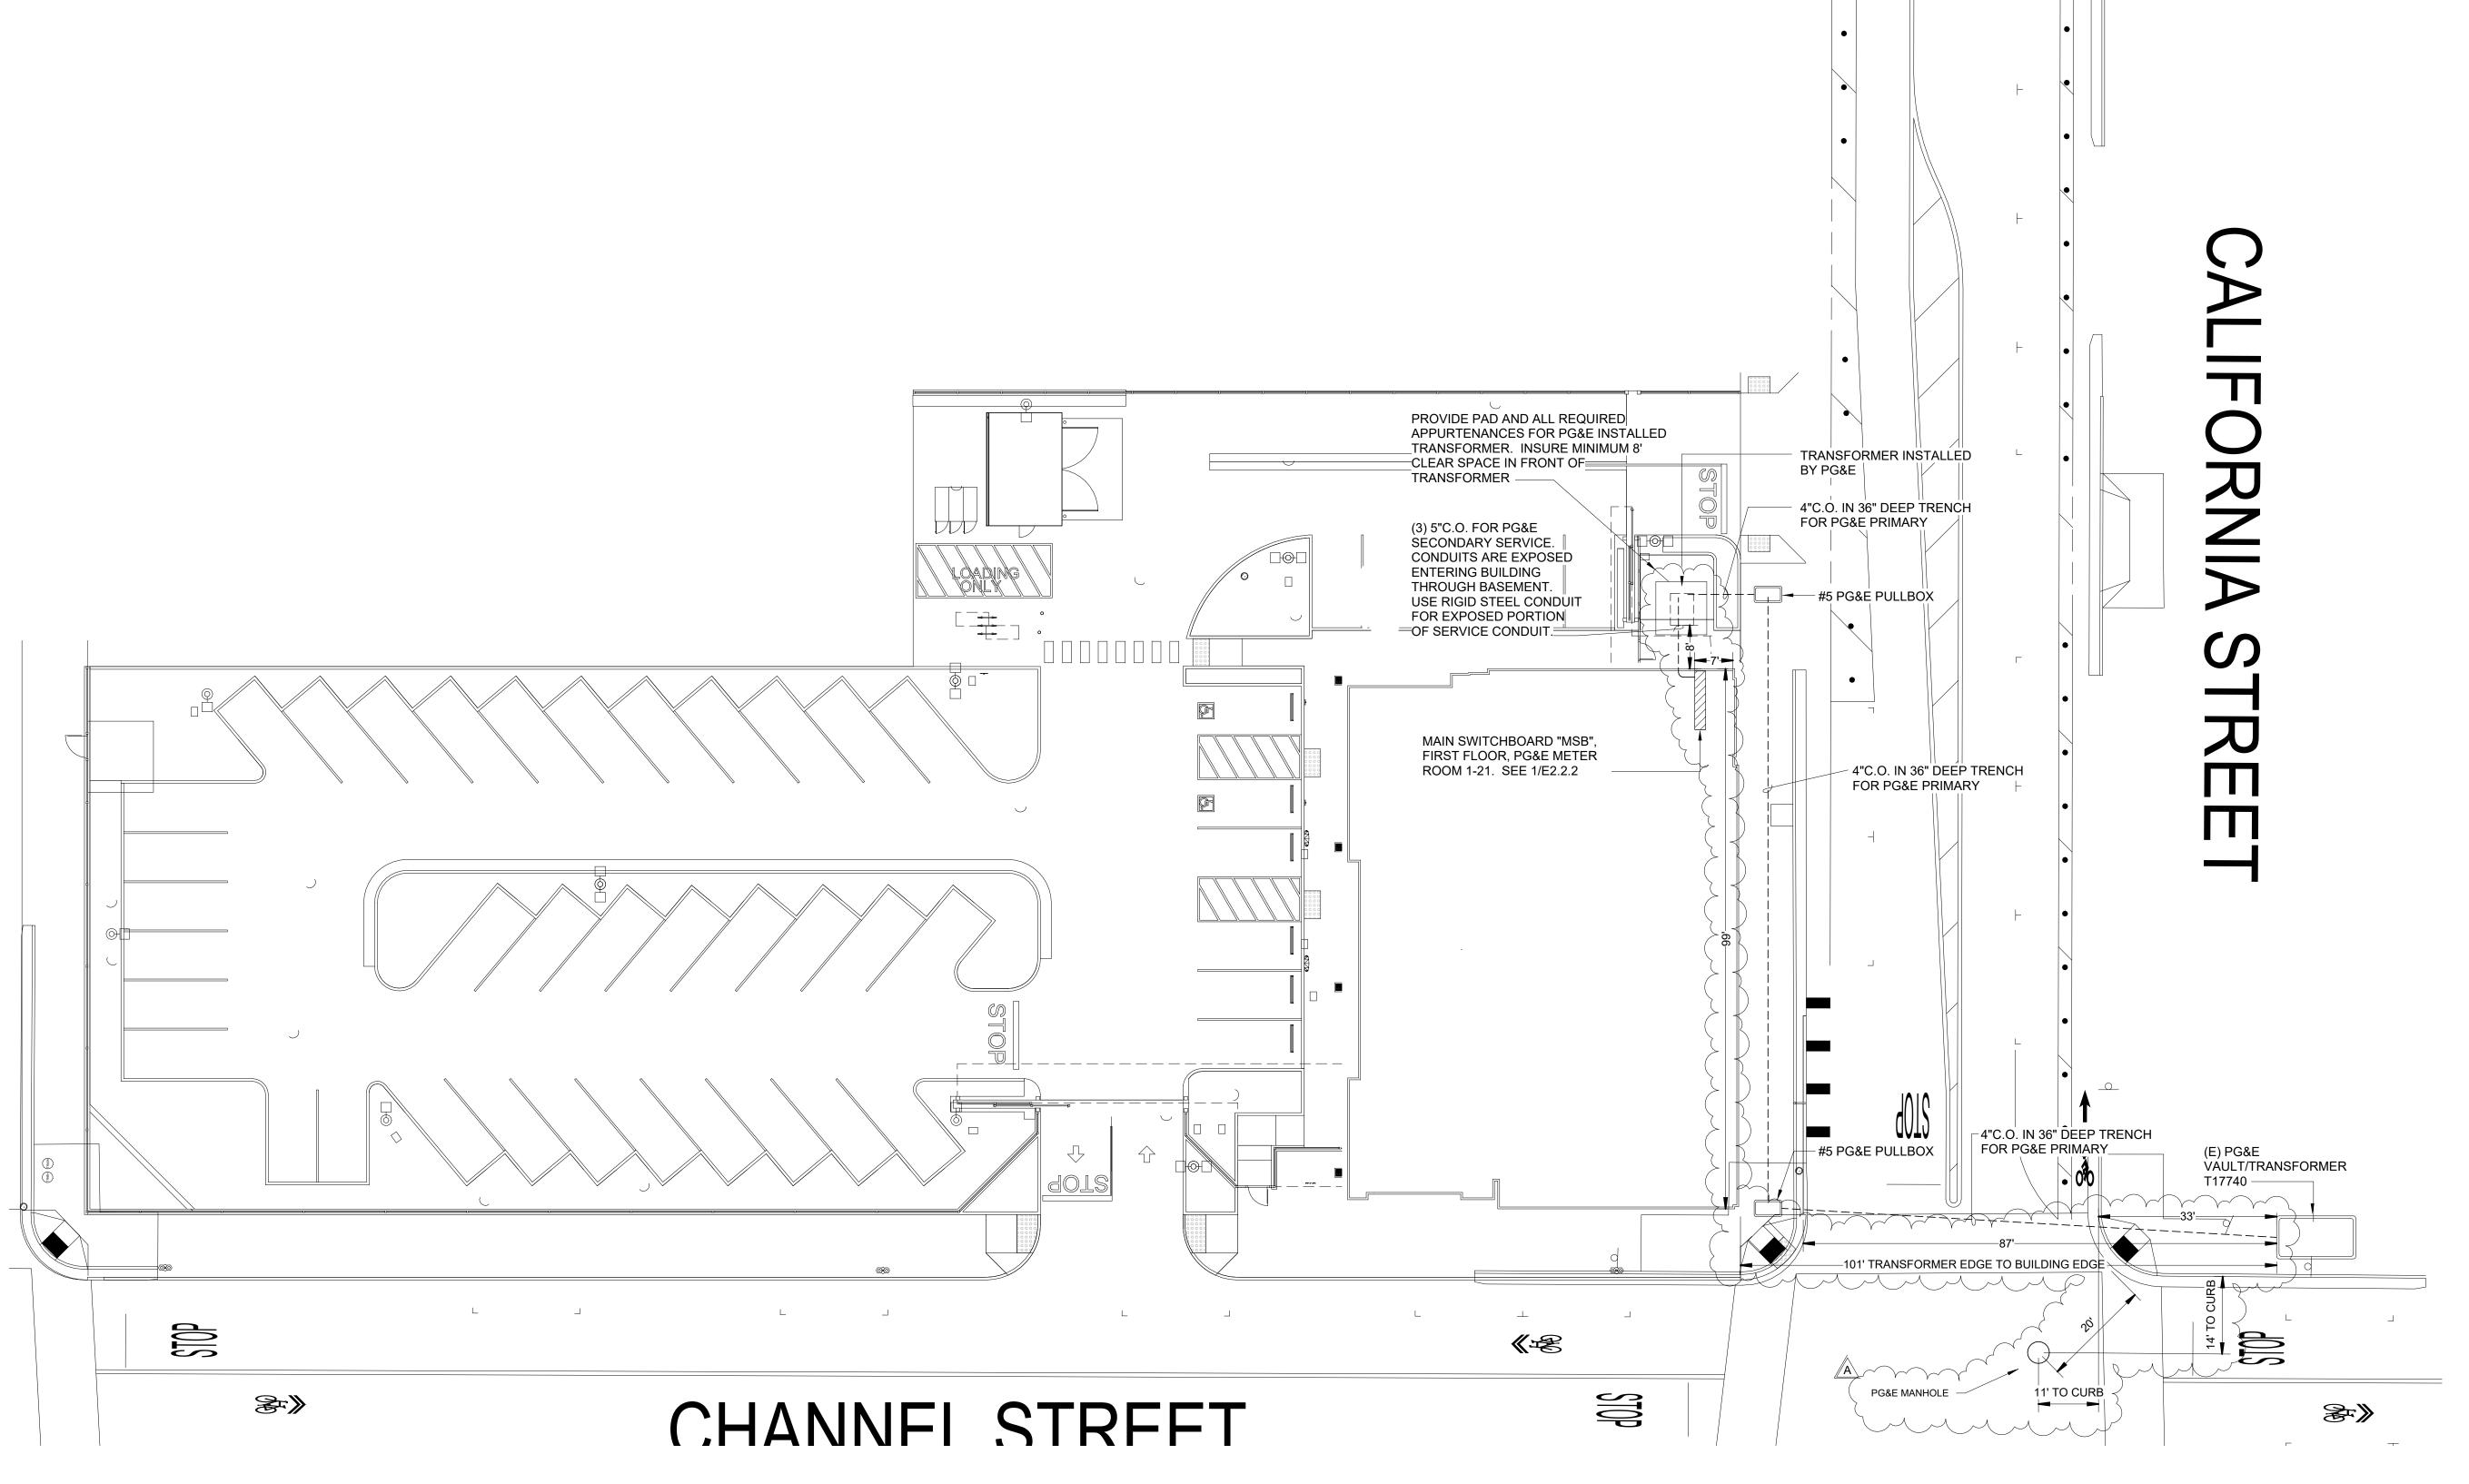

Site Plan - PG&E Connection

E1.3 / 1/16" = 1'-0"

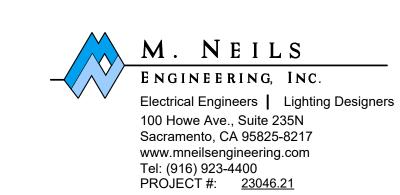

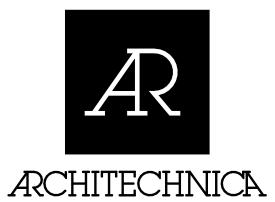

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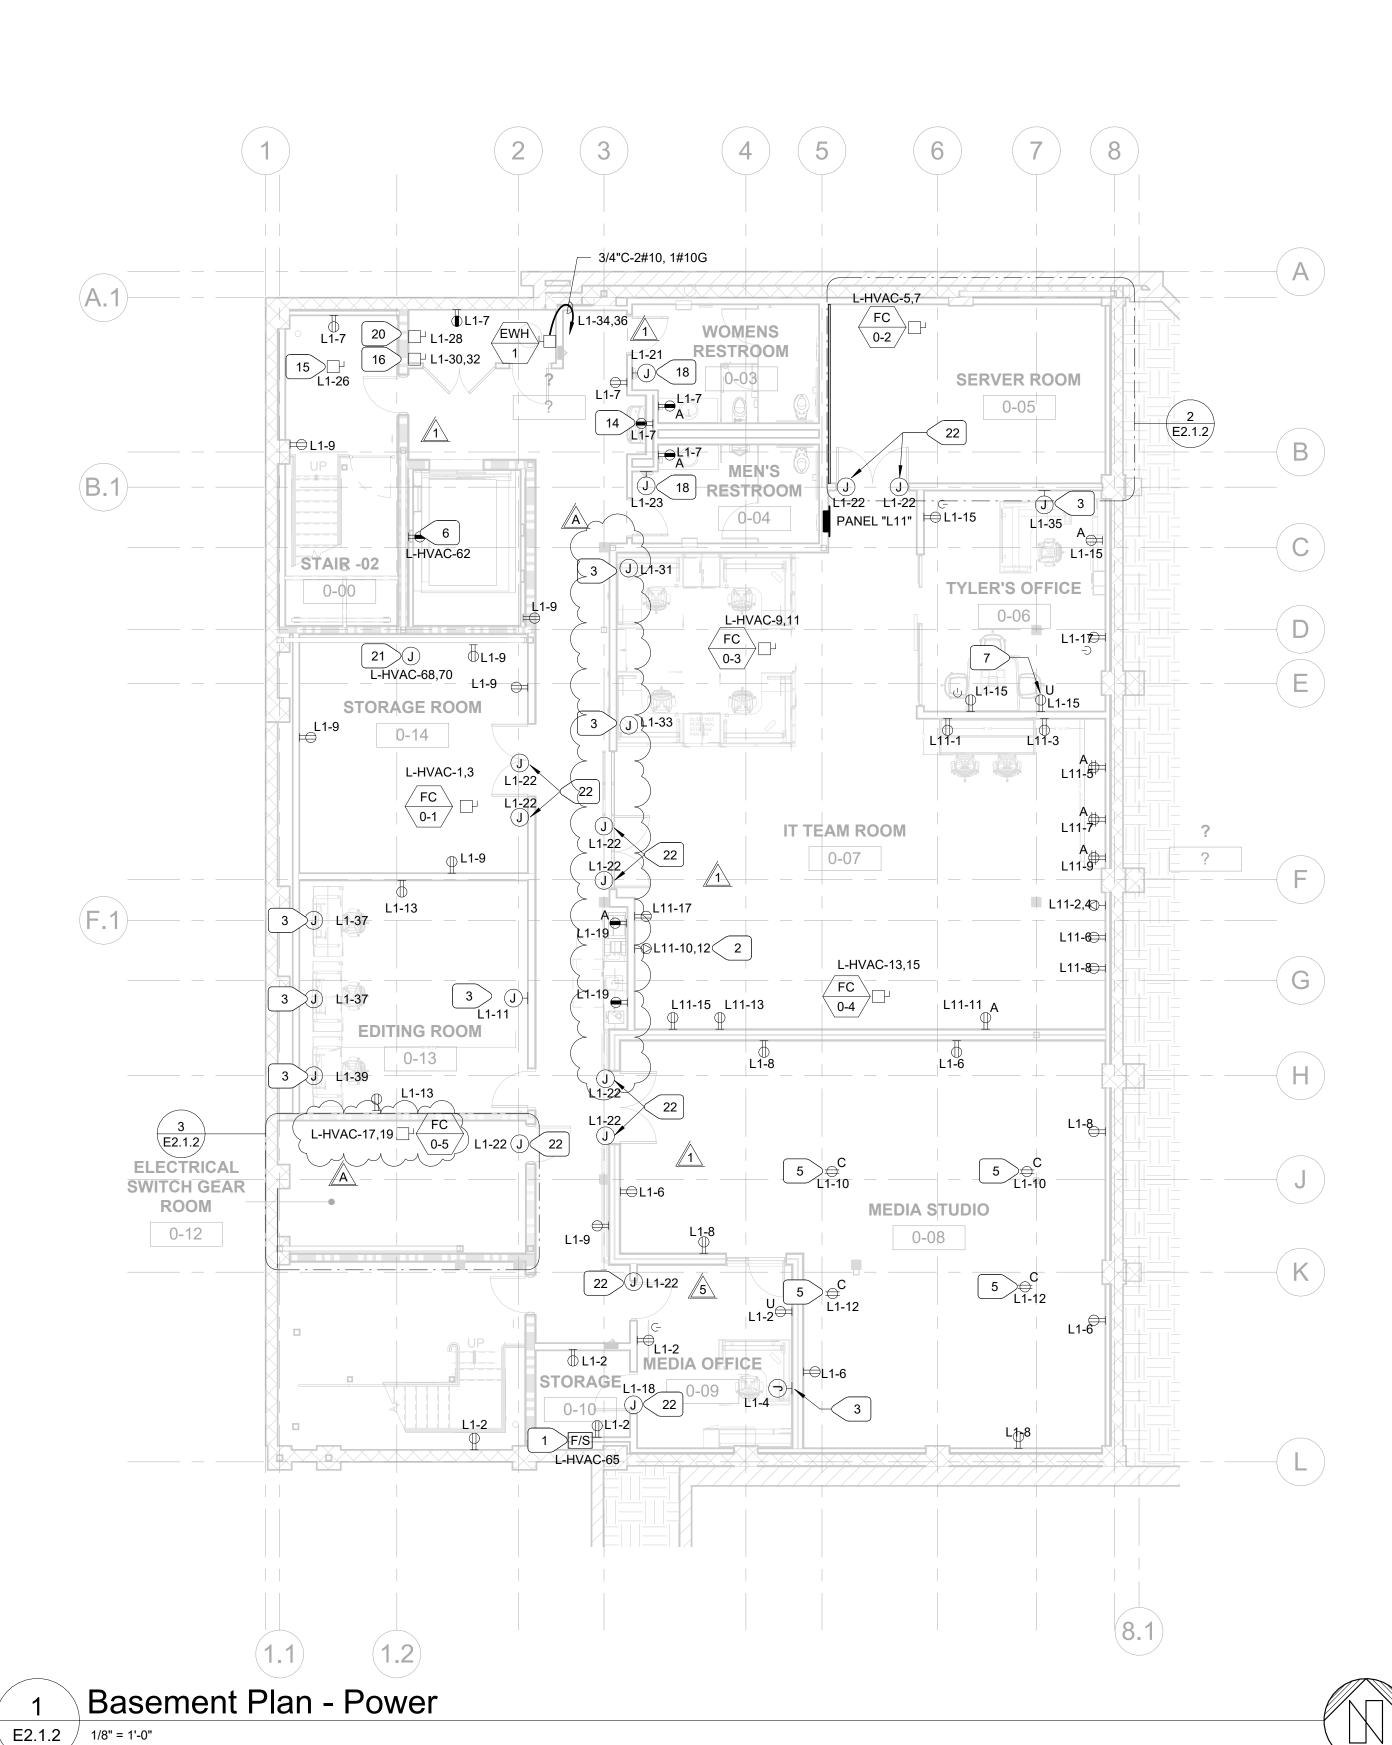
SAN JOAQUIN COUNTY OFFICE OF EDUCATION

	REVISIONS	
1	In House Revisions	8/13
4	Interwest Plancheck Review	9/12
5	Stockton Fire Review	9/16
Α	Interwest Corrections	11/25

PROJECT NO: 23046.21 ISSUE SET: CD Drawings ISSUE DATE: 09-26-2024

DRAWN BY: BR

SITE PLAN - PG&E CONNECTION



3 Electrical Switchgear Room
E2.1.2 1/4" = 1'-0"

Server Room

DISTRIBUTION

PANEL "LDP"

TRANSFORMER "TR"

PANEL

"H-HVAC"

17 H-LTG-16

17 H-LTG-14

PANEL


"H-LTG"

E2.1.2 / 1/4" = 1'-0"

"EM" LIGHT INVERTER"




Tel: (916) 923-4400 PROJECT #: <u>23046.21</u>

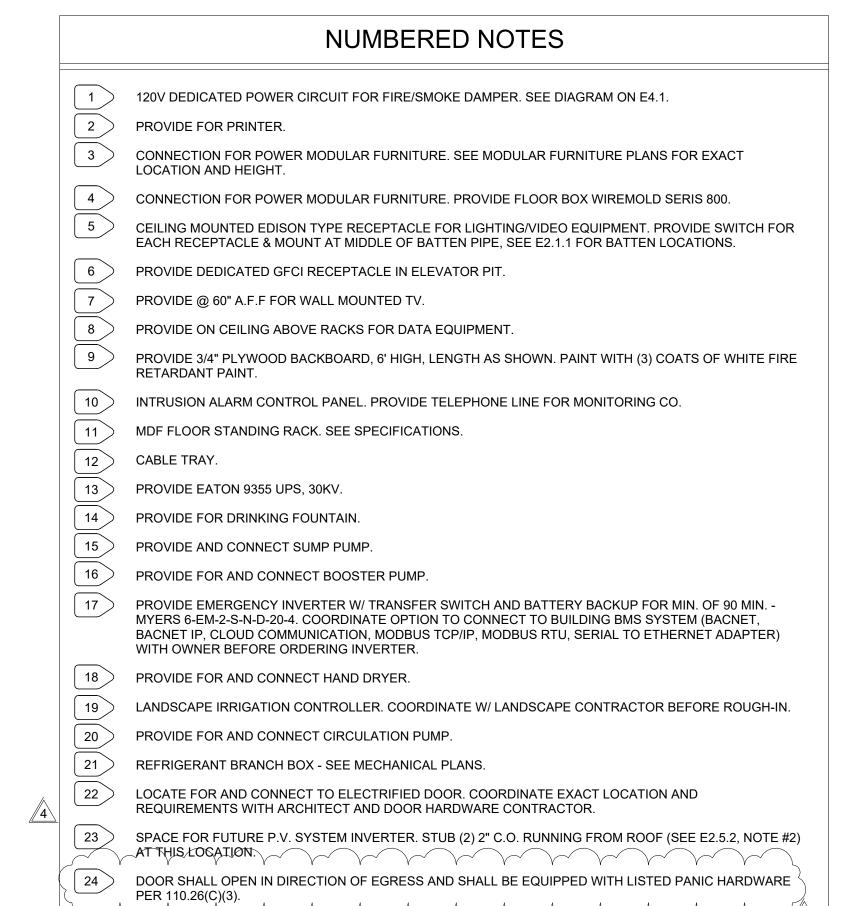


24 A

LIGHTING

CONTROLLER

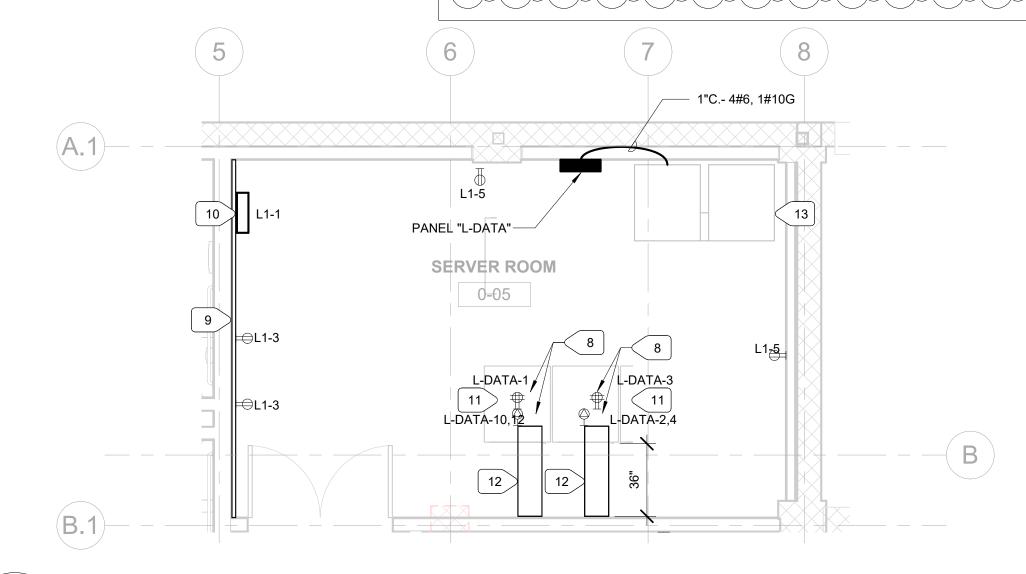

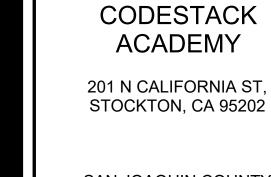

# SAN JOAQUIN COUNTY OFFICE OF EDUCATION REVISIONS

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$\underline{\qquad}$	INEVISIONS		
1	In House Revisions	8/1	
4	Interwest Plancheck Review	9/1	
5	Stockton Fire Review	9/1	
Α	Interwest Corrections	11/2	
PROJECT NO: 23046.21			

ISSUE SET: CD Drawings
ISSUE DATE: 09-26-2024
DRAWN BY: BR

BASEMENT PLAN -POWER

E2.1.2